

Modification to Development Plan Application

Application to the Planning & Zoning Commission



City of Groveport
Building & Zoning Department
655 Blacklick St
Groveport, OH 43125
614-830-2045

Date: 8-2-24
Case # Z-2024-0130
Fee: \$150.00

Address of property 6 vacant lots at the end of Crow Ave., located on the side of

 Crow street / road / avenue.

Parcel # 185-002871-00;185-002872-00; 185-002873-00; 185-002874-00; 185-002875-00; 185-002876-00

Applicant Name: Michael D. Bull, Esq Phone: 614-534-1355

Address: 3740 Ridge Mill Drive Hilliard, OH 43026

Owner Name: Top Gun Investments, LLC Phone: 419-953-4298

Address: 560 E Town St., Columbus OH 43215

The property is currently being used for: vacant land

The property is currently zoned: PR-6 PLANNED LOW DENSITY RESIDENTIAL

I am requesting modification to the following items in the development plan:
to modify the development plan from single family dwelling alone to allow for two-family dwelling
to reduce the first floor size requirement from 750 sqft to no less than 630 sqft; to not require
basements; to modify the requirement of parking slab in addition to one-car garage; to reduce
the size requirement of side-yards between residents

Submittal Requirements: Applicant shall submit this application including the property owners list (see attached form), the filing fee, and twenty (20) copies of the following items to make a complete packet. Also, submit an electronic version on a thumb drive or send by PDF to buildingclerk@groveport.org.

- Drawings, site plan, information, and any other plans that may be applicable.
- Statement of how the proposed modification will affect the original development plan and the reasons for such modification.
- Any additional information that may be helpful to the Planning & Zoning Commission.



Michael D. Bull
Applicant's Signature

614-534-1355
Contact phone number

Michael D Bull esq
Applicant's Printed Name

michael@lmcounsel.com
Email address

PROPERTY OWNERS LIST

List of all property owners within, contiguous to, and directly across the street from such proposed development. List must be in accordance with the Franklin County Auditor's current tax list and must include all the below information.

The Auditor's website is: www.franklincountyauditor.com Go to *Real Estate, Property Search*, put your address in, then go to *Mapping*, and then *Buffer Search*. If you need assistance, call the City of Groveport Building Department at 614-830-2045.

Parcel Number: 185-000637 & 185-000638 & 185-000752

Owner's Name: Joyce J Mounts
Address: 363 Kinsel Ave
City & State: Groveport OH Zip Code 43125

Site Address: Vacant Land off Crow Ave

Mail Address: Name: Joyce J Mounts
Address: 363 Kinsel Ave.,
City & State: Groveport OH Zip Code 43125

Parcel Number: 185-001833

Owner's Name: Lutheran Social Services of Central Ohio - Groveport Housing
Address: 283 Green Ave
City & State: Groveport OH Zip Code 43125

Site Address: 283 Green Ave Groveport OH 43125

Mail Address: Name: Lutheran Social Services of Central Ohio
Address: 1105 Schrock Road
City & State: Columbus Ohio Zip Code 43229

Parcel Number: 185-001755

Owner's Name: Denis Popusoi
Address: 282 Fayer Ct
City & State: Groveport, Ohio Zip Code 43125

Site Address: 282 Fayer Ct., Groveport Ohio 43125

Mail Address: Name: Denis Popusoi
Address: 282 Fayer Ct
City & State: Groveport, Ohio Zip Code 43125

If additional space is needed, make copies of this page.

PROPERTY OWNERS LIST

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Parcel Number: 185- 001769

Owner's Name: Newport Village Homeowners Association Inc.
Address: 2700 E DUBLIN GRANVL 3000
City & State: Columbus OH Zip Code 43231

Site Address: Vacant Land off Greenhill Drive, Groveport Ohio 4 3125

Mail Address: Name: NEWPORT VILLAGE HOA
Address: PO BOX 395
City & State: GROVE CITY OH, Zip Code 43123

Parcel Number: _____

Owner's Name: _____
Address: _____
City & State: _____ Zip Code _____

Site Address: _____

Mail Address: Name: _____
Address: _____
City & State: _____ Zip Code _____

Parcel Number: _____

Owner's Name: _____
Address: _____
City & State: _____ Zip Code _____

Site Address: _____

Mail Address: Name: _____
Address: _____
City & State: _____ Zip Code _____

If additional space is needed, make copies of this page.

PROPERTY OWNERS LIST

List of all adjoining property owners, contiguous to, and directly across the street from such proposed development. List must be in accordance with the Franklin County Auditor's current tax list and must include all the below information.

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Parcel Number: 180-000843

Owner's Name: FRANKLIN COUNTY COMM SANITARY SEWER
Address: 373 S High St FL 26
City & State: Columbus Ohio Zip Code 43215

Site Address: MCCLISH Drive -- Groveport Ohio

Mail Address: Name: FRANKLIN COUNTY COMM SANITARY SEWER
Address: 373 S High St FL 26
City & State: Columbus Ohio Zip Code 43215

Parcel Number: 185-001756

Owner's Name: Gary M Washburn Jr., and Andrea Thomas Washburn
Address: 290 Fayer Ct.
City & State: Groveport Oh Zip Code 43215

Site Address: 290 Fayer Ct., Groverport Ohio, 43215

Mail Address: Name: Gary M Washburn Jr., and Andrea Thomas Washburn
Address: 290 Fayer Ct.,
City & State: Groveport OH Zip Code 43215

Parcel Number: 185-000640 & 185-000639

Owner's Name: James M Weeks Jr
Address: 364 KINSEL AVE
City & State: Groveport OH Zip Code 43215

Site Address: 364 KINSEL AVE GROVEPORT OH 43125

Mail Address: Name: James M Weeks Jr
Address: 364 KINSEL AVE
City & State: Groveport OH Zip Code 43215

If additional space is needed, make copies of this page.

PROPERTY OWNERS LIST

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Parcel Number: 185-000687

Owner's Name: Robert D Jones & Patricia A. Jones
Address: 355 Crow Ave
City & State: Groveport, Ohio Zip Code 43125

Site Address: 355 Crow Ave., Groveport Ohio 43125

Mail Address: Name: Robert D. Jones
Address: 8797 TUSCANY ISLES DR
City & State: Punta Gorda, Florida Zip Code 33950

Parcel Number: 185-000617

Owner's Name: Michael SKrastins & Lisa
Address: 361 Crow Ave
City & State: Groveport, Ohio Zip Code 43125

Site Address: 361 Crow Ave., Groveport Ohio 43125

Mail Address: Name: same
Address: _____
City & State: _____ Zip Code _____

Parcel Number: 185-002877

Owner's Name: John C Lind Jr
Address: _____
City & State: _____ Zip Code _____

Site Address: vacant land on Crow Ave. Groveport OH 43125

Mail Address: Name: _____
Address: unkown
City & State: _____ Zip Code _____

If additional space is needed, make copies of this page.



Lardiere McNair
& Stonebrook, Ltd.

A Legal Professional Association

Members

Christopher L. Lardiere, Esq.
Darren A. McNair, Esq.
Chad M. Stonebrook, Esq.

Associates

Santina M. Graceffa, Esq.
Taylor L. Agler, Esq.
Michael D. Bull, Esq.

Of Counsel

Charles H. McClenaghan, Esq.*
Thomas W. Trimble, Esq.
Anthony Delligatti, Jr., Esq.

*Also Admitted in Florida

July 24, 2024

Building & Zoning Department
655 Blacklick Street
Groveport, OH 43125

MODIFICATION FOR DEVELOPMENT PLAN

I am the attorney representing Top Gun Investments LLC, and on its behalf submit the following Modification for Development Plan for consideration by the City of Groveport.

The modification shall be for parcels **185-002871-00; 185-002872-00; 185-002873-00; 185-002874-00; 185-002875-00; 185-002876-00** on Crow Ave., Groveport, Ohio which were transferred to Top Gun Investments LLC via Sherrif's sale in Instrument No. 202306140058725, Recorder's Office, Franklin County, Ohio.

This application is in accordance with Groveport Codified Ordinance 1135.01.

Please review the attached Modification for Development Plan for Newport Village Section 5 to allow the conditional use for multi-family dwellings to be constructed on PR-6 zoned vacant parcels.

This request specifically is to transform the parcels from single family use to a two-family housing use with housing not to be less than 630 square feet per unit – a modification from the development plan which requires a minimum of 750 for a first-floor development. Notably this is a requirement by the current development plan we are petitioning to modify, not a size standard from 1156.02 of the Groveport Development standards, where there is no minimum tract size if all adjacent lands are platted and developed

A second modification is that basements will not be a part of this development due to feasibility issues with the soil. A soil report was completed and stated it was not feasible to lower the subgrade.

Additionally, a modification on the parking requirements will be necessary. Each side of the two-family residence have a single car garage and a driveway, allowing for two parked cars per unit and four parked cars per parcel. Currently the development plan calls for a one-car garage and a concrete slab to the side of the house to allow for two cars to be parked. With a two-family dwelling this modification would allow for the same number of cars to be parked per parcel, and with the driveway each side of the duplex would have the capacity to park two cars.

A final modification will be to permit less than 50 yards of side yard in between the residences. There will be side yard on both sides of the parcel. Additionally, the houses around the cul-de-sac are angled so as the sides of the houses will not line up parallel to the neighbor. Finally, no side windows or windows directly facing a neighboring property (in this project or preexisting) are contemplated as part of the development proposal and trees are to be added between the residences. See attached drawings for greater detail.

We at Top Gun Investments LLC believe all these proposed modifications are within the current characteristics and spirit of the development plan. Additionally, Section 5 of Newport Village is so remotely located compared to the other Sections of this plan that no adverse effects to the Newport Village plan as a whole are anticipated by deviation from the original development plan.

There is also no anticipated additional strain or exhaustion of the community resources and public services such as schooling or police/fire as this will only result in a marginal increase, if any, in the expected residential population on these parcels.

Greater detail on these proposed development plan modifications is included with this application below, as well as a memorandum of support. Should you have any questions, or if any supplemental documentation is required, please let us know.

Respectfully Submitted,

/s/ Michael D. Bull, Esq.

Michael D. Bull (0100968)

Lardiere McNair & Stonebrook, Ltd., LPA

3740 Ridge Mill Drive

Hilliard, OH 43026

T: 614-534-1355

F: 614-319-3746

michael@lmcounsel.com

1135.01(b)(2) – Vegetation

Current vegetation is to be uninterrupted. No trees are anticipated to be removed. Additional vegetation in terms of replacement grass and additional trees will be included as part of the development. No deforestation or upsetting of the current vegetation will be apart of this process



Currently, as viewed from above, there are very few trees or additional vegetation on the lots whereby after the development:



More Trees will be added than currently exist, increasing the vegetation on these parcels.

1135.01(b)(3) – Soil

A full soil report has been completed. For the purposes of this development, a modification is without a basement.

From the soil report completed by DHDC Engineering Consulting Services, Inc.:

The proposed construction site is covered by a thin to moderate layer of medium stiff to stiff silty clay soil having moisture content mostly in twenties, followed by thin to moderate layer of very soft to soft and compressible cohesive soil or loose cohesionless soil. It is DHDC's opinion that lowering the subgrade by undercutting will expose the soft and compressible cohesive soil or loose cohesionless subgrade soil.

These weak and compressible subgrade soil will not be suitable to support the building foundation. It is DHDC's recommendation that the finish floor elevation of the proposed building structure should also be not raised by more than two (2) to three (3) feet of new fill above the exposed surface, thus keeping the new surcharge load to a minimum on the below grade weak and compressible subgrade soil.

Therefore, this modification would include no basement. It is the understanding based on this report that housing can be supported without a basement by not lowering the subgrade.



2390 Advanced Business Center Drive
Columbus, Ohio 43228
o: 614-527-7656
www.dhdcinc.com

August 29, 2023

Mr. Chaz Fullenkamp
Stoic Properties
Columbus, Ohio


RE: Geotechnical Investigation Report
Newport Village, Section 5
Lots 187 through 193
Groveport, Ohio
DHDC Project Number: PC23-0801

Dear Mr. Fullenkamp:


In compliance with your request, DHDC Engineering Consulting Services, Inc. (DHDC) has completed a subsurface exploration and geotechnical evaluation for the above referenced project. We appreciate the opportunity to be of service to you on this project. If you have any questions regarding our report or if we may be of further service, please contact us at your earliest convenience.

Respectfully submitted,

DHDC Engineering Consulting Services, Inc.


Mohammed O. Haque, P.E.
Geotechnical Engineer




Savvas P. Sophocleous
Project Manager

Attachment



CLIENT Stoic Properties
PROJECT NUMBER PC23-0801
DATE STARTED 8/9/23 **COMPLETED** 8/9/23
DRILLING CONTRACTOR DHDC
DRILLING METHOD Hollow Stem Auger
LOGGED BY Brian **CHECKED BY** M.O.H.
NOTES _____

PROJECT NAME Newport Village - Section 5
PROJECT LOCATION Groveport, Ohio
GROUND ELEVATION _____ **HOLE SIZE** inches
GROUND WATER LEVELS:
 ▽ **AT TIME OF DRILLING** 5.00 ft
 ▼ **AT END OF DRILLING** 4.00 ft
AFTER DRILLING ---

GEO TECH BH COLUMNS - GINT STD US LAB.GDT - 8/27/23 20:27 - C:\USERS\SUNDEIDROPBOX\FAMILY ROOM\SUNDEEPIGINT FILES\NEWPORT VILLAGE SECTIONS_STOIC PROPERTIES.GPJ

DEPTH (ft)	GRAPHIC LOG	MATERIAL DESCRIPTION	ELEVATION (ft)	SAMPLE TYPE NUMBER	RECOVERY % (RQD)	BLOW COUNTS (N VALUE)	POCKET PEN. (tsf)	DRY UNIT WT. (pcf)	MOISTURE CONTENT (%)	ATTERBERG LIMITS			FINES CONTENT (%)
										LIQUID LIMIT	PLASTIC LIMIT	PLASTICITY INDEX	
0		TOPSOIL (8")											
		Medium Stiff, Dark Blackish Brown, SILTY CLAY (CL), some sand, trace gravel, Moist		SS 1	56	1-2-4 (6)	2.5		26	36	22	14	73
		Medium Stiff, Mottled Brown and Gray, SILTY SANDY CLAY (CL), trace gravel [Glacial Till], Moist		SS 2	17	5-3-3 (6)	1.5		23	35	19	16	57
		▼ Very Loose to Loose, Brown and Gray, SILTY SAND (SM), little gravel, Wet		SS 3	44	0-0-0 (0)							
5				SS 4	67	8-1-3 (4)							21
		Medium Dense, Brown and Gray, fine to coarse SAND (SP), some gravel, trace silt, Wet		SS 5	100	8-12-15 (27)							
				SS 6	56	10-11-15 (26)							
10		Very Stiff, Gray, SILTY SANDY CLAY (CL), little gravel [Glacial Till], Wet		SS 7	100	7-10-11 (21)	4.5+		11				
				SS 8	100	8-10-12 (22)	4.5+		11				57
				SS 9	100	5-7-9 (16)	2.0		10				
15		Stiff, Gray, SILTY SANDY CLAY (CL), little gravel [Glacial Till], Wet		SS 10	83	3-6-9 (15)	2.0		11				
				SS 11	67	4-6-8 (14)	2.0		12				
		Medium Dense, Brown and Gray, fine to coarse SAND (SP), some gravel, trace silt, Wet		SS 12	89	3-15-6 (21)							
		Dense, Brown and Gray, fine to coarse SILTY SAND (SM), some gravel, Wet		SS 13	100	10-15-18 (33)							
20		---Coarse GRAVEL/COBBLE within the soil matrix---		SS 14	100	16-18-22 (40)							
				SS 15	100	50/3"							
		Hard, Gray, SILTY SANDY CLAY (CL), little gravel [Glacial Till], Wet		SS 16	50	10-13-18 (31)							
25				SS 17	100	8-16-21 (37)							

Boring discontinued at 25.5 feet depth
 Boring caved at 21.2 feet



CLIENT Stoic Properties
PROJECT NUMBER PC23-0801
DATE STARTED 8/9/23 **COMPLETED** 8/9/23
DRILLING CONTRACTOR DHDC
DRILLING METHOD Hollow Stem Auger
LOGGED BY Brian **CHECKED BY** M.O.H.
NOTES _____

PROJECT NAME Newport Village - Section 5
PROJECT LOCATION Groveport, Ohio
GROUND ELEVATION _____ **HOLE SIZE** inches
GROUND WATER LEVELS:
 ▽ **AT TIME OF DRILLING** 5.50 ft
 ▼ **AT END OF DRILLING** 4.00 ft
AFTER DRILLING ---

GEOTECH BH COLUMNS - GINT STD US LAB.GDT - 8/27/23 20:28 - C:\USERS\SUNDEIDROP\BOX\FAMILY ROOM\SUNDEE\PINGINT FILES\NEWPORT VILLAGE SECTIONS_STOIC PROPERTIES.GPJ

DEPTH (ft)	GRAPHIC LOG	MATERIAL DESCRIPTION	ELEVATION (ft)	SAMPLE TYPE NUMBER	RECOVERY % (RQD)	BLOW COUNTS (N VALUE)	POCKET PEN. (tsf)	DRY UNIT WT. (pcf)	MOISTURE CONTENT (%)	ATTERBERG LIMITS			FINES CONTENT (%)
										LIQUID LIMIT	PLASTIC LIMIT	PLASTICITY INDEX	
0		TOPSOIL (14")											
		Medium Stiff, Mottled Brown and Gray, SILTY CLAY (CL) , trace to little sand, trace gravel [Glacial Till], Moist		SS 1	67	1-2-3 (5)			25	38	23	15	
		Loose, Brown and Gray, fine to medium SILTY SAND (SM) , little gravel, Wet		SS 2	100	2-2-5 (7)	2.0		24				
				SS 3	33	2-2-3 (5)			21				
				SS 4	72	0-1-7 (8)							
		Medium Dense, Brown and Gray, fine to coarse SAND (SP) , some gravel, trace silt, Wet		SS 5	86	4-4-50/2"							
				SS 6	56	3-8-7 (15)							
		Very Stiff to Stiff, Gray, SILTY SANDY CLAY (CL) , little gravel [Glacial Till], Wet		SS 7	100	4-8-12 (20)	3.0		14				
				SS 8	100	3-5-6 (11)	2.25		14				
				SS 9	100	2-3-6 (9)	1.75		12				
				SS 10	100	2-3-6 (9)	2.0		15				
		Medium Dense to Dense, Brown and Gray, fine to coarse SAND (SP) , some gravel, trace silt, Wet		SS 11	100	2-5-11 (16)							
		---Interbedded thin Gray, SILTY SANDY CLAY layers--- ---Coarse GRAVEL/COBBLE within the soil matrix---		SS 12	100	4-9-12 (21)							
				SS 13	67	29-24-24 (48)							
				SS 14	100	14-15-16 (31)							
				SS 15	72	18-19-24 (43)							
		Hard, Gray, SILTY SANDY CLAY (CL) , little gravel [Glacial Till], Wet		SS 16	44	16-18-21 (39)							
				SS 17	67	16-16-13 (29)							

Boring discontinued at 25.5 feet depth
 Boring caved at 20.7 feet



CLIENT Stoic Properties
PROJECT NUMBER PC23-0801
DATE STARTED 8/9/23 **COMPLETED** 8/9/23
DRILLING CONTRACTOR DHDC
DRILLING METHOD Hollow Stem Auger
LOGGED BY Brian **CHECKED BY** M.O.H.
NOTES _____

PROJECT NAME Newport Village - Section 5
PROJECT LOCATION Groveport, Ohio
GROUND ELEVATION _____ **HOLE SIZE** inches
GROUND WATER LEVELS:
 ▽ **AT TIME OF DRILLING** 6.00 ft
 ▼ **AT END OF DRILLING** 5.00 ft
AFTER DRILLING ---

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DEPTH (ft)	GRAPHIC LOG	MATERIAL DESCRIPTION	ELEVATION (ft)	SAMPLE TYPE NUMBER	RECOVERY % (RQD)	BLOW COUNTS (N VALUE)	POCKET PEN. (tsf)	DRY UNIT WT. (pcf)	MOISTURE CONTENT (%)	ATTERBERG LIMITS			FINES CONTENT (%)
										LIQUID LIMIT	PLASTIC LIMIT	PLASTICITY INDEX	
0		TOPSOIL (16")											
		Medium Stiff, Mottled Brown and Gray, SILTY CLAY (CL), trace to little sand, trace gravel [Glacial Till], Moist		SS 1	100	2-2-3 (5)			22				
		Soft, Mottled Brown and Gray, SILTY CLAY (CL), little sand, trace gravel [Glacial Till], Very Moist		SS 2	100	1-2-4 (6)	2.0		19				
		Very Soft, Mottled Dark Brown and Gray, SANDY CLAY (CL), trace gravel [Glacial Till], Very Moist to Wet		SS 3	56	2-2-2 (4)	1.0		21	36	19	17	
		Stiff to Very Stiff, Gray, SILTY SANDY CLAY (CL), little gravel [Glacial Till], Wet		SS 4	33	0-0-2 (2)	0.25		25				
		Hard, Gray, SILTY SANDY CLAY (CL), little gravel [Glacial Till], Wet		SS 5	100	5-6-7 (13)	4.0		12				
		---Interbedded thin SILTY SAND and GRAVEL layers--- ---Coarse GRAVEL/COBBLE within the soil matrix---		SS 6	100	4-8-8 (16)	2.5		14				
		Very Stiff to Stiff, Gray, SILTY SANDY CLAY (CL), little gravel [Glacial Till], Wet		SS 7	100	6-12-23 (35)	2.0						
		---Coarse GRAVEL/COBBLE within the soil matrix---		SS 8	100	4-14-18 (32)	2.5						
		Very Stiff to Stiff, Gray, SILTY SANDY CLAY (CL), little gravel [Glacial Till], Wet		SS 9	100	14-20-20 (40)	3.0						
		Medium Dense to Dense, Brown and Gray, fine to coarse SAND (SP), some gravel, trace silt, Wet		SS 10	100	5-6-10 (16)							
		---Interbedded thin Gray, SILTY SANDY CLAY layers---		SS 11	56	2-4-6 (10)							
				SS 12	100	3-7-7 (14)							
				SS 13	100	5-8-8 (16)							
				SS 14	100	16-12-14 (26)							
				SS 15	0	27-18-20 (38)							
				SS 16	67	16-17-12 (29)							
		Very Stiff, Gray, SILTY SANDY CLAY (CL), little gravel [Glacial Till], Wet		SS 17	56	7-11-14 (25)							

Boring discontinued at 25.5 feet depth
 Boring caved at 21.2 feet



CLIENT Stoic Properties
PROJECT NUMBER PC23-0801
DATE STARTED 8/9/23 **COMPLETED** 8/9/23
DRILLING CONTRACTOR DHDC
DRILLING METHOD Hollow Stem Auger
LOGGED BY Brian **CHECKED BY** M.O.H.
NOTES

PROJECT NAME Newport Village - Section 5
PROJECT LOCATION Groveport, Ohio
GROUND ELEVATION _____ **HOLE SIZE** inches
GROUND WATER LEVELS:
 ▽ **AT TIME OF DRILLING** 15.50 ft
 ▼ **AT END OF DRILLING** 9.30 ft
AFTER DRILLING ---

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DEPTH (ft)	GRAPHIC LOG	MATERIAL DESCRIPTION	ELEVATION (ft)	SAMPLE TYPE NUMBER	RECOVERY % (RQD)	BLOW COUNTS (N VALUE)	POCKET PEN. (tsf)	DRY UNIT WT. (pcf)	MOISTURE CONTENT (%)	ATTERBERG LIMITS			FINES CONTENT (%)
										LIQUID LIMIT	PLASTIC LIMIT	PLASTICITY INDEX	
0		TOPSOIL (18") with rock fragments		SS 1	56	2-2-4 (6)							
		Stiff, Dark Blackish Brown, SILTY CLAY (CL), trace sand, trace gravel, Moist		SS 2	72	2-5-7 (12)	2.0		22	36	19	17	
		Medium Stiff, Mottled Brown and Gray, SILTY CLAY (CL), trace to little sand, trace gravel [Glacial Till], Moist		SS 3	100	2-3-4 (7)	2.0		19				
5		Medium Stiff, Dark Grayish Brown, SILTY CLAY (CL), little sand, little gravel [Glacial Till], Very Moist		SS 4	100	1-2-4 (6)			27				
		Very Stiff to Hard, Gray, SILTY SANDY CLAY (CL), little gravel [Glacial Till], Moist		SS 5	100	3-7-9 (16)	3.0		13				
		---Coarse GRAVEL/COBBLE within the soil matrix---		SS 6	100	4-7-9 (16)							
10				SS 7	100	17-28-24 (52)							
				SS 8	22	4-10-11 (21)							
				SS 9	100	10-10-12 (22)							
15				SS 10	100	5-9-15 (24)							
				SS 11	100	13-15-12 (27)							
		Very Dense to Dense, Brown and Gray, fine to coarse SAND (SP), some gravel, trace silt, Wet		SS 12	72	10-15-21 (36)							
		---Interbedded thin Gray, SILTY SANDY CLAY layers---		SS 13	100	18-23-30 (53)							
20				SS 14	100	24-18-20 (38)							
				SS 15	44	14-19-21 (40)							
				SS 16	100	20-20-25 (45)							
25		Hard, Gray, SILTY SANDY CLAY (CL), little gravel [Glacial Till], Wet		SS 17	100	24-24-20 (44)							

Boring discontinued at 25.5 feet depth
 Boring caved at 23.1 feet



CLIENT Stoic Properties
PROJECT NUMBER PC23-0801
DATE STARTED 8/9/23 **COMPLETED** 8/9/23
DRILLING CONTRACTOR DHDC
DRILLING METHOD Hollow Stem Auger
LOGGED BY Brian **CHECKED BY** M.O.H.
NOTES _____

PROJECT NAME Newport Village - Section 5
PROJECT LOCATION Groveport, Ohio
GROUND ELEVATION _____ **HOLE SIZE** inches
GROUND WATER LEVELS:
 ▽ **AT TIME OF DRILLING** 18.00 ft
 ▼ **AT END OF DRILLING** 5.70 ft
AFTER DRILLING ---

GEOTECH BH COLUMNS - GINT STD US LAB.GDT - 8/27/23 20:28 - C:\USERS\SUNDEID\ROFBOX\FAMILY ROOM\SUNDEE\PINGINT FILES\NEWPORT VILLAGE SECTIONS_STOIC PROPERTIES.GPJ

DEPTH (ft)	GRAPHIC LOG	MATERIAL DESCRIPTION	ELEVATION (ft)	SAMPLE TYPE NUMBER	RECOVERY % (RQD)	BLOW COUNTS (N VALUE)	POCKET PEN. (tsf)	DRY UNIT WT. (pcf)	MOISTURE CONTENT (%)	ATTERBERG LIMITS			FINES CONTENT (%)
										LIQUID LIMIT	PLASTIC LIMIT	PLASTICITY INDEX	
0		TOPSOIL (14")											
		Medium Stiff, Mottled Brown and Gray, SILTY CLAY (CL) , trace to little sand, trace gravel [Glacial Till], Moist		SS 1	67	1-1-3 (4)			21				
		Soft, Mottled Brown and Gray, SILTY CLAY (CL) , little sand, little gravel [Glacial Till], Very Moist		SS 2	100	2-3-5 (8)	2.0		20				
		Medium Dense, Brown and Gray, fine to coarse SAND (SP) , some gravel, trace silt, Wet		SS 3	56	1-2-1 (3)	0.5		21				
5		Stiff to Very Stiff, Gray, SILTY SANDY CLAY (CL) , little gravel [Glacial Till], Wet		SS 4	56	2-7-5 (12)							
		Stiff to Very Stiff, Gray, SILTY SANDY CLAY (CL) , little gravel [Glacial Till], Wet		SS 5	100	6-8-11 (19)	4.5+		11				
				SS 6	56	8-9-9 (18)							
				SS 7	100	5-6-7 (13)							
				SS 8	100	8-7-7 (14)							
				SS 9	67	4-8-8 (16)							
				SS 10	100	5-6-5 (11)							
				SS 11	72	5-7-11 (18)							
				SS 12	100	15-17-12 (29)							
		Medium Dense, Brown and Gray, fine to coarse SAND (SP) , some gravel, trace silt, Wet		SS 13	100	5-7-7 (14)							
				SS 14	67	5-9-11 (20)							
				SS 15	56	10-10-15 (25)							
				SS 16	67	11-13-17 (30)							
				SS 17	61	10-10-15 (25)							

Boring discontinued at 25.5 feet depth
 Boring caved at 20.2 feet



CLIENT Stoic Properties
PROJECT NUMBER PC23-0801
DATE STARTED 8/9/23 **COMPLETED** 8/9/23
DRILLING CONTRACTOR DHDC
DRILLING METHOD Hollow Stem Auger
LOGGED BY Brian **CHECKED BY** M.O.H.
NOTES _____

PROJECT NAME Newport Village - Section 5
PROJECT LOCATION Groveport, Ohio
GROUND ELEVATION _____ **HOLE SIZE** inches
GROUND WATER LEVELS:
 ▽ **AT TIME OF DRILLING** 7.50 ft
 ▼ **AT END OF DRILLING** 6.00 ft
AFTER DRILLING ---

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DEPTH (ft)	GRAPHIC LOG	MATERIAL DESCRIPTION	ELEVATION (ft)	SAMPLE TYPE NUMBER	RECOVERY % (RQD)	BLOW COUNTS (N VALUE)	POCKET PEN. (tsf)	DRY UNIT WT. (pcf)	MOISTURE CONTENT (%)	ATTERBERG LIMITS			FINES CONTENT (%)
										LIQUID LIMIT	PLASTIC LIMIT	PLASTICITY INDEX	
0		TOPSOIL (14")											
		Medium Stiff, Dark Blackish Brown, SILTY CLAY (CL), trace sand, trace gravel, Moist		SS 1	100	1-1-3 (4)			17	35	21	14	
		Medium Stiff, Mottled Brown and Gray, SILTY CLAY (CL), trace to little sand, trace gravel [Glacial Till], Moist		SS 2	83	1-3-6 (9)	1.75		24				
				SS 3	28	2-2-3 (5)	1.5		22				
5		Soft, Mottled Brown and Gray, SILTY CLAY (CL), trace to little sand, trace gravel [Glacial Till], Very Moist		SS 4	44	1-1-2 (3)	0.5		30				
		Dense to Medium Dense, Brown and Gray, fine to coarse SAND (SP), some gravel, trace silt, Wet		SS 5	100	6-16-16 (32)							
		Very Stiff to Hard, Gray, SILTY SANDY CLAY (CL), little gravel [Glacial Till], Wet		SS 6	100	12-20-10 (30)			14				
10		---Coarse GRAVEL/COBBLE within the soil matrix---		SS 7	100	4-8-12 (20)			10				
				SS 8	61	12-17-19 (36)							
				SS 9	100	12-17-24 (41)							
				SS 10	100	20-25-25 (50)							
				SS 11	72	12-15-21 (36)							
				SS 12	88	9-50/2"							
				SS 13	50	50/2"							
20		Dense to Very Dense, Brown and Gray, fine to coarse SAND (SP), some gravel, trace silt, Wet		SS 14	56	12-25-40 (65)							
		---Interbedded thin Gray, SILTY SANDY CLAY layers---		SS 15	44	20-20-25 (45)							
				SS 16	27	23-38-50/3"							
25		Hard, Gray, SILTY SANDY CLAY (CL), little gravel [Glacial Till], Wet		SS 17	56	21-32-45 (77)							

Boring discontinued at 25.5 feet depth
 Boring caved at 20.7 feet



CLIENT Stoic Properties
PROJECT NUMBER PC23-0801
DATE STARTED 8/9/23 **COMPLETED** 8/9/23
DRILLING CONTRACTOR DHDC
DRILLING METHOD Hollow Stem Auger
LOGGED BY Brian **CHECKED BY** M.O.H.
NOTES _____

PROJECT NAME Newport Village - Section 5
PROJECT LOCATION Groveport, Ohio
GROUND ELEVATION _____ **HOLE SIZE** inches
GROUND WATER LEVELS:
 ▽ **AT TIME OF DRILLING** 18.00 ft
 ▼ **AT END OF DRILLING** 9.60 ft
AFTER DRILLING ---

GEOTECH BH COLUMNS - GINT STD US LAB.GDT - 8/27/23 20:28 - C:\USERS\SUNDEID\ROFBOX\FAMILY ROOM\SUNDEE\PINGINT FILES\NEWPORT VILLAGE SECTIONS_STOIC PROPERTIES.GPJ

DEPTH (ft)	GRAPHIC LOG	MATERIAL DESCRIPTION	ELEVATION (ft)	SAMPLE TYPE NUMBER	RECOVERY % (RQD)	BLOW COUNTS (N VALUE)	POCKET PEN. (tsf)	DRY UNIT WT. (pcf)	MOISTURE CONTENT (%)	ATTERBERG LIMITS			FINES CONTENT (%)
										LIQUID LIMIT	PLASTIC LIMIT	PLASTICITY INDEX	
0		TOPSOIL (14")											
		Fill: Brown, SILTY CLAY , little sand, little gravel, Moist		SS 1	44	1-2-3 (5)			8				
		---Rock fragments in sample---		SS 2	67	10-15-15 (30)			8				
		Fill: Dark Brown, SILTY SAND , little gravel, Moist		SS 3	100	5-5-6 (11)	2.5		23				
		Fill: Mottled Brown and Gray, SILTY CLAY , trace to little sand, trace gravel, Moist		SS 4	78	3-7-8 (15)	2.5		24				
		Stiff, Dark Blackish Brown, SILTY CLAY (CL) , trace sand, trace gravel, Moist		SS 5	100	4-4-5 (9)	2.0						
		Stiff, Mottled Brown and Gray, SILTY CLAY (CL) , trace to little sand, trace gravel [Glacial Till], Moist		SS 6	100	5-6-5 (11)	3.0						
		Stiff, Gray, SILTY SANDY CLAY (CL) , little gravel [Glacial Till], Moist to Wet		SS 7	67	3-4-10 (14)							
		▼ ---Coarse GRAVEL/COBBLE within the soil matrix---		SS 8	33	4-6-9 (15)							
				SS 9	78	4-4-8 (12)							
				SS 10	61	6-6-7 (13)							
				SS 11	100	6-6-7 (13)							
				SS 12	100	4-6-8 (14)							
				SS 13	100	5-30-32 (62)							
		Dense, Brown and Gray, fine to coarse SAND (SP) , some gravel, trace silt, Wet		SS 14	67	12-17-20 (37)							
		---Coarse GRAVEL/COBBLE within the soil matrix---		SS 15	56	15-20-26 (46)							
				SS 16	61	10-12-21 (33)							
				SS 17	83	13-17-20 (37)							

Boring discontinued at 25.5 feet depth
 Boring caved at 20.8 feet

1135.01(b)(4) – Selected Use

The current parcels are all zoned the same for all six parcels. These are PR-6, Planned low density residential districts as part of the Newport Village Section 5. It is important to note that this is an undeveloped section of the Newport Village plan and that this section (Section 5) is far removed from all additional sections in the Newport Village plan.

Via the 1156.02 Development standards, PR-6 there is no minimum tract size if all adjacent lands are platted and developed. Further yet, two family dwellings are accounted for in this act (see min. yard space requirements). So, it is not as if duplex/two-family dwellings aren't considered as part of this PR-6 development, we are just applying to allow the Newport 5 Section to include said two-family dwellings.

The development plan, however, requires first floors with a minimum of 750 sq.ft. This modification would be to permit structures that include first floors that are not less than 630 sq.ft.

PR-6, is regulated in the land use matrix under 1153.03 as conditional for two-family dwelling and townhouse structures. “Such uses may only be allowed in a zoning district when such conditional use, its location, extent, and method of development will not substantially alter the character of the vicinity or unduly interfere with the use of adjacent lots in the manner prescribed for the zoning district in addition to the development standards for the zoning district.” *See 1153.03.*

Here, the land is undeveloped so there is no character to be substantially altered. Further yet, as a residential lot, there will be no undue interference with adjacent lots. These two-family dwellings should be in total similarly sized to similar houses down Crow Ave. These residential areas will have no change in their use or ability to continue to maintain a single-family dwelling. Further yet, both of the adjacent parcels with residential housing currently built are currently not owner occupied, with the owners living out of Groveport and in one instance out of State.

Finally, with this area (Section 5) being far removed from the additional Newport Village sections, the variation from the Newport Village sections should not be considered a change to adjacent parcels, nor should it be considered a adverse change to the other Newport Village sections currently developed.

Therefore, there is no substantial alteration of the character or interference with adjacent lots by allowing this conditional use to be granted for the six-parcels on Crow Ave and as such, in accordance with 1153.03, the City of Groveport should grant this modification to allow the conditional use.

1135.01(b)(5) – Proposed Size, Location, and Use

See site plan for full details. Each plat will be designed with a beautiful two-family housing with separate entrances and garages as well as yard space for occupier use. No public access parks or maintenance facilities will be included in this development.

See proposed architectural designs for full square footage breakdown and Birdseye view layout of the proposed development.

1135.01(b)(7) – Proposed Traffic Pattern

As this modification only affects the cul-de-sac which Crow Ave., dead ends into there is no traffic pattern to create. A minor increase to the traffic on this end of Crow Ave will be expected

1135.01(b)(8) – The proposed schedule of site development, construction of structures, and associated facilities, including sketches and other materials indicating design principles and concepts to be followed in site development, construction, landscaping, and other features.

See sketches attached for guidance on features and design principals. We will work the City of Groveport in order to develop a construction plan that provides a time to get these homes built as soon as possible while continuing to be respectful of our neighbors and good stewards of the land.

1135.01(b)(9) – The relationship of the proposed development to existing and future land use in the surrounding area, the street system, community facilities, services, and other public improvements

This proposed modification will not create unnecessary or unsustainable strain on these public services. The plan for each of these duplexes would be to have two bedrooms per unit. A single-family house built in conjunction with the current development plans could conceivably have 3 or 4 bedrooms without any additional modifications.

Without increasing the population density, we do not anticipate any additional strain on the public services and utilities. The utilities are planned out with existing infrastructure plan. The schools will not see dramatic increases in enrollment versus that which they would in the current development plan. Any police involvement in the area would additionally be expected to be the same as if these lots were developed under the current development plan.

1135.01(b)(10) – Control over land – Deed + Utility map

Deed from Sherriff's sale is included here in. Utility map is provided.

DO NOT DETACH



Instrument Number: 202306140058725

Recorded Date: 06/14/2023 2:21:03 PM



Daniel J. O'Connor Jr.
Franklin County Recorder
373 South High Street, 18th Floor
Columbus, OH 43215
(614) 525-3930
<http://Recorder.FranklinCountyOhio.gov>
Recorder@FranklinCountyOhio.gov

Return To (No Disposition):
N/D

No Disposition

Transaction Number: T20230039773

Document Type: SHERIFFS DEED

Document Page Count: 3

Submitted By (Walk-In):

FRANKLIN COUNTY SHERIFF

Walk-In

First Grantor:

JOHN C LIND , JR

First Grantee:

TOP GUN INVESTMENTS LLC

Fees:

Document Recording Fee: \$34.00

Additional Pages Fee: \$8.00

Total Fees: \$42.00

Amount Paid: \$42.00

Amount Due: \$0.00

Instrument Number: 202306140058725

Recorded Date: 06/14/2023 2:21:03 PM

OFFICIAL RECORDING COVER PAGE

DO NOT DETACH

THIS PAGE IS NOW PART OF THIS RECORDED DOCUMENT

NOTE: If the document data differs from this cover sheet, please first check the document on our website to ensure it has been corrected. The document data always supersedes the cover page.

If an error on the cover page appears on our website after review please let our office know.

COVER PAGE DOES NOT INCLUDE ALL DATA, PLEASE SEE INDEX AND DOCUMENT FOR ANY ADDITIONAL INFORMATION.

TRANSFERRED

JUN 14 2023

MICHAEL STINZIANO
AUDITOR
FRANKLIN COUNTY, OHIO

90005440

CONVEYANCE TAX EXEMPT E
MICHAEL STINZIANO FRANKLIN COUNTY AUDITOR

SHERIFF'S DEED ON ORDER OF SALE
(Tax Foreclosure)

I, **Dallas L. Baldwin**, Sheriff of Franklin County, Ohio pursuant to the Order of Sale entered on October 13, 2022 in which Franklin County Treasurer Cheryl Brooks Sullivan, duly elected, recovered of John C. Lind Jr., et al. the judgment granted on July 02, 2018 in the amount of \$45,098.93, together with the costs of said action, and in consideration of the sum of \$77,352.56, Top Gun Investments, LLC, on March 24, 2023 having bid for the premises, and there being no other bid offered for the same, the said premises were then and there struck off to Top Gun Investments, LLC, the purchaser, and upon confirmation of Sale, do hereby **GRANT, SELL AND CONVEY** unto Top Gun Investments, LLC all rights, title and interest of the parties in the Court of Common Pleas, Franklin County, Ohio, Case No. 17CV011393, and all pleadings therein incorporated herein by reference in and to the following Lands and Tenements situated in the County of Franklin and State of Ohio, known and described as follows, to wit:

(SEE ATTACHED EXHIBIT A)

This deed does not reflect any restriction, conditions or easements of record.

Prior Owner: John C. Lind Jr.


Property Address(s): 6 Vacant Lots at the end of Crow Avenue, Groveport, OH 43125

Parcel Number(s): 185-002873-00, 185-002871-00, 185-002872-00, 185-002874-00, 185-002875-00, 185-002876-00

Prior Instrument No.: Instrument Number 200403220061852.

Tax Mailing Address: 316 Derrer Road, Columbus, OH 43204

Executed this 7th day of JUNE, 2023.

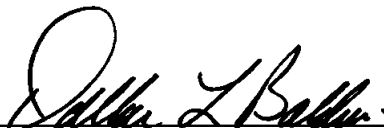

Dallas L. Baldwin
Sheriff of Franklin County, Ohio

STATE OF OHIO,

SS:

COUNTY OF FRANKLIN

The foregoing was acknowledged before me this 7th day of JUNE, 2023 by
Dallas L. Baldwin, Sheriff of Franklin County, Ohio



Lonessa A. Mills
Notary Public, State of Ohio
My Commission Expires 11-1-2026
Section 147.03 R.C.



Notary Public

State of Ohio
My Commission Expires NOV 2, 2026

This instrument was prepared by:
William J. Stehle (0077613)
Assistant Prosecuting Attorney

EXHIBIT A

Situated in the State of Ohio, County of Franklin, and in the Village of Groveport:

Being Lot Numbers 187, 188, 189, 190, 191 and 192 of Newport Village, Section 5, as the same is numbered and delineated upon the recorded plat thereof, of record in Plat Book 109, Pages 19 and 20, Recorder's Office, Franklin County, Ohio.

Parcel Numbers: 185-002871-00, 185-002872-00, 185-002873-00, 185-002874-00, 185-02875-00, 185-002876-00

Addresses: 6 lots Crow Avenue, Groveport, Ohio 43125

Source Deed: Instrument Number 200403220061852, Recorder's Office, Franklin County, Ohio.

1135.01(b)(11) – Economic Feasibility

N/A

1135.01(b)(12) – Landscape planning



1135.01(b)(13) – Proposed signage

No signage is contemplated as part of this development plan.

1135.01(b)(14) – Proposed Fencing

No fencing is contemplated as part of this development plan.



Lardiere McNair
& Stonebrook, Ltd.
A Legal Professional Association

Members

Christopher L. Lardiere, Esq.
Darren A. McNair, Esq.
Chad M. Stonebrook, Esq.

Associates

Santina M. Graceffa, Esq.
Taylor L. Agler, Esq.
Michael D. Bull, Esq.

Of Counsel

Charles H. McClenaghan, Esq.*
Thomas W. Trimble, Esq.
Anthony Delligatti, Jr., Esq.

*Also Admitted in Florida

MEMORANDUM OF SUPPORT

Building & Zoning Department
655 Blacklick Street
Groveport, OH 43125

RE: Development Plan Modification for 6 Vacant Lots on Crow Ave

To Whom it May Concern:

My name is Michael Bull, and I am writing to you on behalf of my client Top Gun Investments, LLC as we are attempting to modify the current development plan to permit multi-family dwellings to be constructed on the vacant land off Crow Ave., in Groveport. This plan would affect parcels numbered **185-002871-00;185-002872-00; 185-002873-00; 185-002874-00; 185-002875-00; 185-002876-00.**

The primary modification here is to amend the development plan which currently calls for single family residential houses to allow for multi-family dwellings. Specifically, we are asking for the modification to allow for two-family homes to be built. What we hope to demonstrate is that this should neither greatly affect the density of the area versus the current development plan, nor should it create additional strain on the community services.

Why Groveport?

Top Gun Investments LLC is excited about the opportunity to develop this currently undeveloped portion of Groveport. This is a community that cares about its families. This is a community with a strong school system. This is a community that supports its civil servants. When the opportunity came at Sherrif's sale to purchase these lots, the decision to purchase was easy.

This is a strong community, but this area off Crow Ave is not developed. Our plan is to improve the land. Our plan is to make this area match the standards that the rest of this City has already set in terms of quality housing and quality residents.

What are the Modifications?

As detailed in our submission, this request specifically is to transform the parcels from single family use to a two-family housing use with housing not to be less than 630 square feet per unit. Indeed, this is a deviation from the existing development plan which requires a minimum of 750 for a first-floor development. Notably this is a requirement by the current development plan we are petitioning to modify, not a size standard from 1156.02 of the Groveport Development standards, where there is no minimum tract size if all adjacent lands are platted and developed

A second modification is that basements will not be a part of this development due to feasibility issues with the soil. A soil report was completed and stated it was not feasible to lower the subgrade.

Additionally, a modification on the parking requirements will be necessary. Each side of the two-family residence has a single car garage and a driveway, allowing for two parked cars per unit and four parked cars per parcel. Currently the development plan calls for a one-car garage and a concrete slab to the side of the house to allow for two cars to be parked. With a two-family dwelling this modification would allow for the same number of cars to be parked per parcel, and with the driveway each side of the duplex would have the capacity to park two cars.

A final modification will be to permit less than 50 yards of side yard in between the residences. There will be side yard on both sides of the parcel. Additionally, the houses around the cul-de-sac are angled so that the sides of the houses will not line up parallel to the neighbor. Finally, no side windows or windows directly facing a neighboring property (in this project or preexisting) are contemplated as part of the development proposal and trees are to be added between the residences.

The key with all of these modifications is that they can be permitted and not dramatically or drastically changes the current characteristics of the neighborhood or the other sections of the Newport Development. Again, Section 5 is so far removed from the other sections of the Newport Development Plan that none of these proposed modifications should adversely effect the whole.

This Modification will not be a Strain Public Services

Schools, utilities, police. Three things that Groveport does exceptionally well. This proposed modification will not create unnecessary or unsustainable strain on these public services. The plan for each of these duplexes would be to have two bedrooms per unit. A single-family house built in conjunction with the current development plans could conceivably have 3 or 4 bedrooms without any additional modifications.

Simply put, this modification request would not substantially increase the population density for the area compared to the current development plan. What this modification would allow, in reality, is for more young families and professionals to move into the Groveport area and find well-built, competitively priced housing in Groveport. All this modification does in actuality is add a second front door and a dividing interior wall to allow two separate renters to find a place to live.

Without increasing the population density, we do not anticipate any additional strain on the public services and utilities. The utilities are planned out with existing infrastructure plan. The schools will not see dramatic increases in enrollment versus that which they would in the current development plan. Any police involvement in the area would additionally be expected to be the same as if these lots were developed under the current development plan.

This Area is Undeveloped/Underdeveloped

As strong a community as Groveport is, there are a few areas that need a facelift. Our plan would provide beautiful houses to an area that has been a vacant lot for several years. This would only serve to increase the value and standard of the neighborhood. Currently, these are merely vacant lots. They have been for the history of this neighborhood. Inserting six new houses would bring life to an area of Groveport that desperately needs it.

This is projected Top Gun Investments is committed to. The plan is not to build and immediately sell the houses, nor is the plan to pawn these new developments off to out of state investors. Top Gun Investments is a locally, central Ohio, owned company. Its owner lives in Central Ohio and is committed to developing these areas outside of Columbus with real houses that work for real families.

Conclusion

This isn't an ask for high density housing. This isn't a plea for luxury apartments that seem to be going up on every street corner in Columbus. Our plan is to build nice houses on these currently vacant lots and split them into duplexes to allow more couples, young professionals, and small families to find a home.

While we are respectful of the process for getting this modification, it really must be emphasized actual real-world effect of these proposed modifications on the neighborhood and existing community is negligible compared to what the current development plan would permit to be built without any such City approval.

Thank you for your consideration. We are eager to begin construction and await Groveport's decision on our application.

Respectfully Submitted,

/s/ Michael D. Bull, Esq.

Michael D. Bull (0100968)

Lardiere McNair & Stonebrook, Ltd., LPA


3740 Ridge Mill Drive

Hilliard, OH 43026

T: 614-534-1355

F: 614-319-3746

michael@lmcounsel.com

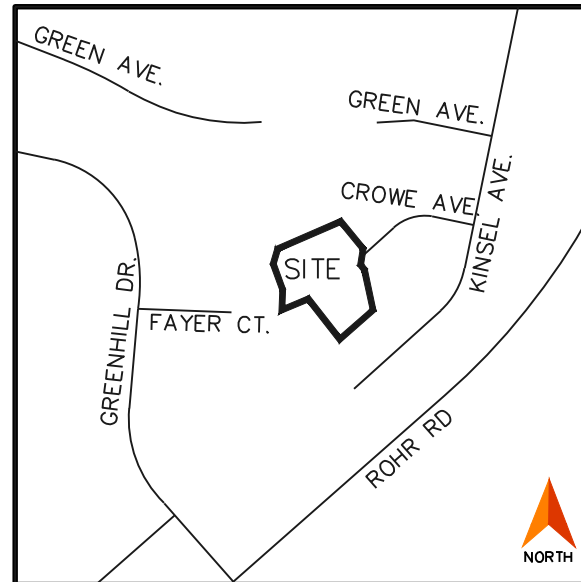

VICINITY MAP
NOT TO SCALE

STOIC PROPERTIES
NEWPORT VILLAGE SECTION 5
SECTION 28, TOWNSHIP 11, RANGE 21
CITY OF GROVEPORT
FRANKLIN COUNTY, OH
CONTAINING - 2.1489 TOTAL ACRES
JULY 2024

SHEET INDEX

COVER SHEET	SHEET NO. 1
EXISTING CONDITIONS – DEMO PLAN	SHEET NO. 2
SITE LAYOUT PLAN	SHEET NO. 3
SITE GRADING & UTILITY PLAN	SHEET NO. 4
UTILITY PROFILES	SHEET NO. 5
SITE SWPPP & STORM WATER QUALITY PLAN	SHEET NO. 6
CITY OF GROVEPORT – STANDARD DWGS-1	SHEET NO. 7
CITY OF GROVEPORT – STANDARD DWGS-2	SHEET NO. 8
CITY OF GROVEPORT – STANDARD DWGS-3	SHEET NO. 9

GENERAL NOTES:

STORM SEWER NOTES

1. PIPE SPECIFICATIONS FOR THE PLAN IMPROVEMENTS SHALL BE IN ACCORDANCE WITH THE FOLLOWING:

REINFORCED CONCRETE PIPE ASTM C-76 (CMSC 706.02). CONCRETE CLASSIFICATION SHALL BE IN CONFORMANCE WITH THE FOLLOWING UNLESS OTHERWISE REFERENCED BY THE PROFILES.

- 12" – 15" DIAMETER PIPE, CLASS IV
- 18" – 24" DIAMETER PIPE, CLASS III
- 30" – 48" DIAMETER PIPE, CLASS II

2. ALL MANHOLES AND INLETS SHALL BE CHanneLED.

3. OPENINGS SHALL BE PROVIDED IN THE DRAINAGE STRUCTURES TO ACCOMMODATE UNDERDRAIN OUTLETS AS DETAILED BY THE PLAN SPECIFICATIONS.

4. ALL BEDDING SHALL BE IN ACCORDANCE WITH COC STANDARD DRAWINGS AA-S151 AND AA-S152 FOR RIGID PIPE SEWER.

5. ANY SETTLEMENT OF STORM SEWER TRENCHES WHICH OCCURS DURING THE GUARANTEE PERIOD SHALL BE REPAIRED AT NO COST TO THE CITY.

SANITARY SEWER NOTES

1. FOR PIPE UP TO AND INCLUDING 15" DIAMETER – EXTRA STRENGTH CLAY PIPE, ASTM C-700, WITH COMPRESSION JOINTS ASTM C-425, OR PVC SEWER PIPE, ASTM D3034, SDR 35 FOR PIPE LARGER THAN 15" DIAMETER – REINFORCED CONCRETE PIPE ASTM C-76 WITH JOINT SPECIFICATIONS PER ASTM C-443 SHALL BE REQUIRED.

2. ALL SANITARY SEWER SERVICES SHALL BE INSTALLED AT A MINIMUM SLOPE OF 2.08% (1/4 INCH PER FOOT).

3. SANITARY SEWER WYE-BRANCHES SHALL BE INSTALLED DURING THE CONSTRUCTION OF THE COLLECTOR SEWERS. IF THE SEWER IS LOCATED WITHIN THE STREET RIGHT-OF-WAY, SERVICE EXTENSIONS SHALL BE MADE TO WITHIN ONE (1) FOOT OF THE RIGHT-OF-WAY.

4. ALL EXISTING INVERTS ALONG WITH THE PROPOSED TOP OF CASTING ELEVATIONS SHALL BE VERIFIED BY THE CONTRACTOR PRIOR TO THE CONSTRUCTION OF THE SEWER.

5. ALL SANITARY SEWER MANHOLE COVERS SHALL CONFORM TO THE CURRENT CITY OF GROVEPORT STANDARD DRAWINGS.

6. ALL NEW SANITARY SEWER MANHOLES INSTALLED IN THE CITY OF GROVEPORT SHALL BE CONSTRUCTED IN ACCORDANCE WITH THE CURRENT CITY STANDARD DRAWINGS.

7. THE CONTRACTOR SHALL FURNISH ALL MATERIAL, EQUIPMENT AND LABOR TO MAKE CONNECTIONS TO EXISTING MANHOLES. THE SEWER PIPE TO MANHOLE CONNECTION ON ALL SANITARY SEWERS SHALL BE FLEXIBLE AND AIRTIGHT. THE SEWER PIPE BARREL AT THE SPRING LINE SHALL NOT EXTEND MORE THAN 1- INCH BEYOND THE INSIDE WALL OF THE MANHOLE. TO MAINTAIN THE FLEXIBILITY IN THE CONNECTION, A 1-INCH SPACE SHALL BE LEFT BETWEEN THE END OF THE PIPE INSIDE THE MANHOLE AND THE CONCRETE CHANNEL; THIS SPACE SHALL BE FILLED WITH WATERPROOF FLEXIBLE JOINT FILLER. ANY METAL THAT IS USED SHALL BE 300 SERIES STAINLESS STEEL. THE CONNECTION MAY BE MADE BY THE FOLLOWING TYPES:

RUBBER SLEEVE WITH STAINLESS STEEL BANDING:

- 1. KOR-N-SEAL AS MANUFACTURED BY NATIONAL POLLUTION CONTROL SYSTEMS, INC.
- 2. LOCK JOINT FLEXIBLE MANHOLE SLEEVE AS MANUFACTURED BY INTERPACE CORPORATION.
- 3. OR EQUAL.

RUBBER GASKET COMPRESSION:

- 1. PRESS WEDGE II AS MANUFACTURED BY PRESS-SEAL GASKET CORPORATION
- 2. DURA SEAL III AS MANUFACTURED BY DURA TECH INC.
- 3. LINK-SEAL AS MANUFACTURED BY THUNDERLINE CORP.
- 4. OR EQUAL.

8. ALL PRECAST CONCRETE PRODUCTS SHALL BE INSPECTED AT THE LOCATION OF MANUFACTURE. ALL CONCRETE PIPE AND STORM OR SANITARY SEWER STRUCTURES SHALL BE STAMPED OR HAVE SUCH IDENTIFICATION NOTING THAT SAID PIPE AND STORM OR SANITARY STRUCTURES HAVE BEEN INSPECTED BY THE CITY OF COLUMBUS AND MEET THEIR SPECIFICATIONS. PIPE AND STRUCTURES WITHOUT PROPER IDENTIFICATION WILL NOT BE PERMITTED FOR INSTALLATION.

9. THE CONTRACTOR SHALL ENSURE THAT THERE IS A SURVEYOR'S LEVEL AND ROD ON THE PROJECT FOR USE IN PERFORMING GRADE CHECKS WHENEVER SEWER LINE STRUCTURES OR PIPE ARE BEING INSTALLED. THE CONTRACTOR SHALL MAKE THIS EQUIPMENT AVAILABLE FOR USE BY, AND ASSIST, THE CITY INSPECTOR IN PERFORMING GRADE CHECKS WHEN REQUESTED BY THE INSPECTOR. THE INSPECTOR WILL MAKE ALL REASONABLE ATTEMPTS TO CONFINE REQUESTS FOR ASSISTANCE IN PERFORMING GRADE CHECKS TO TIMES CONVENIENT TO THE CONTRACTOR.

SANITARY SEWER NOTES (CONT'D)

THE CHECK WILL BE PERFORMED TO ENSURE THE FOLLOWING:

- 1. PROPER PLACEMENT OF EACH STRUCTURE.
- 2. PROPER INSTALLATION OF INITIAL RUNS OF PIPE FROM A STRUCTURE.
- 3. GRADE, AFTER AN OVERNIGHT OR LONGER SHUTDOWN.
- 4. GRADE, AT ANY OTHER TIME THE INSPECTOR HAS REASON TO QUESTION THE GRADE OF INSTALLATION.

GRADE CHECK PERFORMED BY THE CITY INSPECTOR IN NO WAY RELIEVES THE CONTRACTOR FROM THE ULTIMATE RESPONSIBILITY OF ENSURING CONSTRUCTION TO THE PLAN GRADE.

10. BUILDING SEWERS SHALL NOT BE CONSTRUCTED CLOSER THAN THREE FEET TO ANY EXTERIOR WALL, CELLAR, BASEMENT OR CISTERN NOR SHALL THEY HAVE LESS THAN TWO FEET OF EARTH OR STONE COVER.

11. IN THE EVENT THE TRENCH IS EXCAVATED BELOW THE REQUIRED GRADE OF THE PIPE, THE EXCESS SPACE SHALL BE FILLED WITH STONE AS SPECIFIED BY THE SEWER INSPECTOR. THE WIDTH OF THE TRENCH AT THE TOP OF PIPE SHALL NOT EXCEED TWO FEET PLUS THE OUTSIDE DIAMETER OF THE PIPE NOR SHALL THE WIDTH BE LESS THAN ONE FOOT PLUS THE OUTSIDE DIAMETER OF THE PIPE.

12. WHEN UNSTABLE, SOFT OR SPONGY CONDITIONS ARE ENCOUNTERED AT THE TRENCH BOTTOM, SUCH MATERIAL SHALL BE REMOVED AND REPLACED WITH CLEAN, CRUSHED STONE SUFFICIENT TO STABILIZE THE TRENCH BOTTOM TO SUPPORT THE PIPE TO A TRUE LINE AND GRADE IN ACCORDANCE WITH CMSC 906. SUCH WORK SHALL BE PERFORMED AS DIRECTED BY THE CITY ENGINEER.

13. TAMPING IN FINELY GRADED SOIL OR GRANULAR MATERIAL IN SIX INCH LAYERS SHALL BACKFILL THE BUILDING SEWER TO AN ELEVATION AT LEAST TWELVE INCHES OVER THE TOP OF PIPE. SOILS CONTAINING STONES LARGER THAN TWO INCHES SHALL NOT BE USED FOR ANY PORTION OF THE BACKFILL.

14. NO FIRM, PERSON OR CORPORATION SHALL DISCHARGE OR PERMIT THE DISCHARGE OF ANY DELETERIOUS WASTES INTO THE SEWAGE SYSTEM. SUCH WASTES ARE DEFINED AS OILS, ACIDS, CYANIDES, POISONS AND ANY OTHER SUBSTANCES, GAS OR LIQUID WHICH MAY IN ANY WAY DAMAGE OR INTERFERE WITH THE USE OR OPERATION OF THE SANITARY SEWERS OR SEWAGE TREATMENT PLANT AND MAY CREATE A HAZARD TO LIFE OR PROPERTY.

15. NO DOWNSPOUTS, SURFACE INLETS, FOUNDATION DRAINS, SUB-SURFACE DRAINS OR ANY OTHER SOURCE OF GROUND OR SURFACE WATER SHALL BE CONNECTED EITHER DIRECTLY OR INDIRECTLY TO DISCHARGE INTO ANY PART OF THE PUBLIC OR PRIVATE SANITARY SEWER SYSTEM. SAID DRAINS, INLETS AND DOWNSPOUTS SHALL BE CONSTRUCTED TO DRAIN OR TO BE PUMPED INTO THE STREET, GUTTER, DITCH OR THE STORM SEWER.

WATER NOTES

1. THE CITY OF COLUMBUS CONSTRUCTION AND MATERIALS SPECIFICATIONS, 2018 EDITION AND ALL REVISIONS INCLUDING ALL SUPPLEMENTS THERETO, SHALL GOVERN ALL CONSTRUCTION ITEMS THAT ARE PART OF THIS PLAN UNLESS OTHERWISE NOTED.

2. ALL WATER MAIN MATERIAL AND INSTALLATIONS SHALL BE IN ACCORDANCE WITH THE CURRENT RULES AND REGULATIONS OF THE CITY OF COLUMBUS, DIVISION OF WATER. ALL CITY OF COLUMBUS, DIVISION OF WATER STANDARD DRAWINGS SHALL APPLY TO THIS PROJECT UNLESS OTHERWISE NOTED.

3. ALL BRASS FITTINGS ASSOCIATED WITH WATER WORK, INCLUDING REPAIRS TO THE EXISTING SYSTEM, SHALL CONFORM TO THE REVISED ALLOWABLE LEAD EXTRACTION LIMIT PER THE UPDATED NSF/ANSI 61 STANDARD. THE DIVISION OF WATER'S APPROVED MATERIALS LIST HAS BEEN UPDATED TO REFLECT THIS REQUIREMENT.

4. ONLY ONE CONNECTION TO AN EXISTING WATER MAIN IS PERMITTED BEFORE DISINFECTION OF A NEW WATER MAIN HAS BEEN COMPLETED. ALL OTHER CONNECTIONS MUST BE MADE AFTER THE MAIN HAS BEEN DISINFECTED.

5. WHEN PERFORMING WATER SERVICE LINE TRANSFERS, THE CONTRACTOR SHALL FLUSH THE WATER TAP PRIOR TO CONNECTING TO THE EXISTING SERVICE LINE.

6. WHEN CROSSING THE EXISTING WATER MAIN, AND LMSB (ITEM 636) IS BEING USED AS BACKFILL, THE CONTRACTOR SHALL PROVIDE NO. 57 CRUSHED CARBONATE STONE (CCS) ONE FOOT BELOW TO ONE FOOT ABOVE THE EXISTING WATER MAIN.

WATER NOTES (CONT'D)

7. ALL WATER MAIN VALVE BOXES, WATER TAP BOXES, TEST STATIONS, PITOMETER TAP STRUCTURES, METER PIT COVERS, AND OTHER SURFACE UTILITY STRUCTURES WITHIN THE DISTURBED AREA SHALL BE ADJUSTED TO GRADE. ANY OF THESE STRUCTURES LOCATED WITHIN PAVEMENT, DRIVEWAYS, OR OTHER TRAVELED AREAS, WHETHER EXISTING OR PROPOSED, SHALL BE EQUIPPED WITH A TRAFFIC RATED, HEAVY DUTY VALVE BOX AND/OR COVER IN ACCORDANCE WITH THE STANDARD DRAWINGS. EXISTING WATER TAP BOXES TO REMAIN THAT ARE ENCOUNTERED WITHIN THE PROJECT LIMITS SHALL BE CLEANED OUT, CENTERED OVER THE CURB STOP, AND ADJUSTED TO THE PROPOSED GRADE.

8. WHERE NEW CONDUIT IS PROPOSED TO CROSS AN EXISTING OR PROPOSED WATER MAIN OR WATER TAP/SERVICE LINE, A MINIMUM OF 12-INCHES OF VERTICAL CLEARANCE SHALL BE MAINTAINED BETWEEN THE CONDUIT AND THE WATER MAIN OR TAP/SERVICE LINE. A MINIMUM OF 3- FEET OF HORIZONTAL CLEARANCE (OUT TO OUT) IS REQUIRED AT LOCATIONS WHERE THE CONDUIT IS PARALLEL TO THE WATER MAIN AND AT LOCATIONS OF WATER MAIN THRUST BLOCKS.

9. A MINIMUM OF 3 FEET OF HORIZONTAL CLEARANCE (OUT TO OUT) SHALL BE MAINTAINED BETWEEN ALL EXISTING WATER MAINS AND FOUNDATIONS FOR POLES, PULL BOXES, PUSH BUTTON PEDESTALS, AND ANY OTHER MISCELLANEOUS ELECTRICAL STRUCTURE.

10. A MINIMUM OF 4 FEET OF COVER IS REQUIRED PRIOR TO PRESSURE TESTING ANY WATER MAIN. A SUFFICIENT AMOUNT OF BACKFILL SHALL BE INSTALLED TO PROVIDE THE ADEQUATE RESTRAINT IN AREAS WHERE REQUIRED.

11. THE CONTRACTOR SHALL COORDINATE HIS WORK SUCH THAT NO WATER CUSTOMER WILL HAVE THEIR SERVICE DISRUPTED MORE THAN TWO (2) TIMES THROUGHOUT THE DURATION OF THIS PROJECT.

12. ALL WATER METERS ASSOCIATED WITH THIS PROJECT SHALL BE INSTALLED INSIDE THE PROPOSED STRUCTURE UNLESS A METER PIT IS APPROVED BY THE ADMINISTRATOR OF THE DIVISION OF WATER. ALL METER PITS MUST CONFORM TO STANDARD DRAWING L-7103 FOR 5/8" THROUGH 1" METERS OR L-6317 A, B, C, D, & E FOR 1-1/2" OR LARGER METERS.

13. ALL FIRE HYDRANTS SHALL BE IN ACCORDANCE WITH THE CURRENT CITY OF GROVEPORT FIRE HYDRANT STANDARD DRAWINGS AND SHALL BE AWWA APPROVED.

14. ALL EXCAVATION, BACKFILL, BEDDING, FITTINGS CONCRETE BACKING, ETC. REQUIRED TO PERFORM THE WORK SHALL BE INCLUDED IN THE PRICE BID FOR ITEM 801. WATERLINES SHALL BE LAID WITH 4 FEET OF COVER, MINIMUM, IN CASE OF CONFLICT BETWEEN THE WATERLINES AND SEWERS, EITHER EXISTING OR PROPOSED, THE WATERLINES SHALL BE LOWERED DURING CONSTRUCTION.

15. WATER MAINS AND EXISTING OR PROPOSED SEWERS SHALL BE SEPARATED BY 18" VERTICALLY AND A MINIMUM OF 10' HORIZONTALLY. THIS SEPARATION SHALL CONFORM TO ALL THE REQUIREMENTS OF THE "TEN STATE" STANDARDS.

16. THE NORMAL WORKING PRESSURE IN THE WATERLINES SHALL NOT BE LESS THAN 35 PSI. INDIVIDUAL BOOSTER PUMPS WILL NOT BE ALLOWED FOR ANY INDIVIDUAL SERVICE.

17. THE PROPOSED WATERLINE SHALL BE LOCATED A MINIMUM DISTANCE OF TWENTY FEET AWAY FROM ANY STRUCTURE, OVERHANG OR FOOTER.

18. NO SERVICE LINES SHALL BE LESS THAN THREE-QUARTER INCH IN DIAMETER. IF NECESSARY TO PROVIDE ADEQUATE SUPPLY AND PRESSURES, LARGER SIZE LINES MAY BE REQUIRED BY THE BUILDING INSPECTOR.

19. NO WATER SERVICE LINE SHALL BE LAID IN THE SAME TRENCH WITH GAS, ELECTRICAL, SEWER OR SEWER SERVICE LINES.

20. SERVICES SHALL BE CONSTRUCTED AFTER THE STREET IS ROUGH GRADED AND PRIOR TO INSTALLATION OF THE PROPOSED PAVED SURFACES AND CURBS. THEY MAY BE LAID IN OPEN TRENCH PROVIDED THAT THE TRENCH IS FILLED WITH GRANULAR BACKFILL IN THE PROPOSED PAVING AREAS OR JACKED UNDER THE GROUND SURFACE FROM OPENINGS AT THE BACK OF THE PROPOSED CURB.

21. ALL VALVE BOXES, SERVICE BOXES AND FIRE HYDRANTS SHALL BE LOCATED WITHIN EASEMENT AREAS OR RIGHT-OF-WAY.

22. BACKFILLING OF ALL WATERLINE TRENCHES AND EXCAVATIONS SHALL BE IN ACCORDANCE WITH CMSC ITEM 801. ALL WATERLINE EXCAVATION SHALL BE CONSIDERED TO BE UNDER OR WITHIN THE INFLUENCE LINE OF THE PAVEMENT AND BACKFILLING SHALL FOLLOW THE REQUIREMENTS OF CMSC ITEM 801.11. NO GRITS WILL BE PERMITTED IN THE WATERLINE TRENCH BACKFILL.

23. CURB BOXES SHALL BE LOCATED ONE FOOT FROM THE EDGE OF THE SIDEWALK, BETWEEN THE SIDEWALK AND THE CURB, OR TWO FEET FROM THE RIGHT-OF-WAY LINE WHEN NO SIDEWALK IS PRESENT OR PROPOSED. ALL CURB BOXES SHALL BE ADJUSTED TO FINISHED GROUND SURFACES. ALL CURB BOXES SHALL BE IN ACCORDANCE WITH THE CURRENT CITY STANDARD DRAWINGS. WHEN THE STREET IS CURBED, A "W" SHALL BE STAMPED IN THE FACE OF CURB OPPOSITE EACH CURB BOX BEFORE THE CONCRETE IS SET.

WATER NOTES (CONT'D)

24. VALVES SHALL BE ADJUSTED TO FINAL GRADE AS DIRECTED BY THE CITY OF GROVEPORT AND/OR ENGINEER. THE CONTRACTOR SHALL INCLUDE THE COST OF VALVE BOX EXTENSIONS AND ADJUSTMENTS AS REQUIRED IN THE PRICE BID FOR VALVES. IF THE TOP OF THE VALVE OPERATING NUT IS MORE THAN 48" BELOW FINISH GRADE, AN EXTENSION STEM SHALL BE FURNISHED TO BRING THE TOP OF THE OPERATING NUT TO WITHIN 36" OF THE FINISHED GRADE.

25. CONCRETE SUPPORTS SHALL BE PROVIDED AT ALL HORIZONTAL AND VERTICAL BENDS, TEES, PLUGS, VALVES, AND HYDRANTS. THE CONTRACTOR IS FULLY RESPONSIBLE FOR PROVIDING CONCRETE BACKING TO THE EXTENT SUFFICIENT TO GUARANTEE THE OPERATION OF THE PIPE UNDER BOTH THE TEST AND DESIGN PRESSURES. REFERENCE THE CITY OF COLUMBUS DIVISION OF WATER STANDARD DRAWINGS L-6310, L-6311, L6312, AND L-7001 FOR CONCRETE BACKING REQUIREMENTS.

VESTING DEED INFORMATION


LOTS 187-192 OF THE SUBDIVISION OF NEWPORT VILLAGE SECTION 5 AS RECORDED IN PB 109, PAGE 19 AND OF THE LANDS OF TOP GUN INVESTMENTS, LLC AS RECORDED IN INSTRUMENT # 202306140058725 OF THE FRANKLIN COUNTY DEED RECORDS, ON FILE IN COLUMBUS, OH

PROPERTY DATA:

PARCEL LOCATION:	NEWPORT VILLAGE SECTION 5 CROW AVENUE CITY OF GROVEPORT FRANKLIN COUNTY, OHIO P.B. 109, PAGE 19
ZONING:	ZONING DISTRICT: PR-6 (PLANNED LOW DENSITY RESIDENTIAL DISTRICT) RESIDENTIAL ZONING: R-4 (TWO-FAMILY DWELLING AND TOWNHOUSES)
FLOOD ZONE:	ZONE "X" AREA OF MINIMAL FLOOD HAZARD FEMA FIRM NUMBER 39049C0432K, EFF. DATE JUNE 17, 2008. THIS FLOOD ZONE DETERMINATION IS MADE BY VISUAL INSPECTION OF THE CURRENT FIRM AND IS NOT AN ACTUAL FEMA ELEVATION CERTIFICATE.



SURVEYOR

J. BRYANT ABT, PS
OHIO P.S. # 8593
BA LAND PROFESSIONALS, LLC
301 BOURBON ST
BLANCHESTER, OH 45107
937.558.6671
HTTPS://BALANDPROS.COM
ABT@BALANDPROS.COM

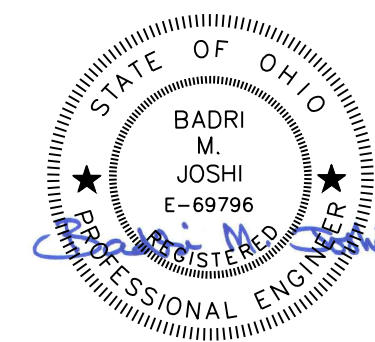

COVER SHEET	
NEWPORT VILLAGE SECTION 5	
CROW AVE CITY OF GROVEPORT	SECTION 28, TOWNSHIP 11, RANGE 21 FRANKLIN COUNTY, OHIO
SCALE: 1" = 20'	DATE: 06/10/2024 REV 07/15/2024
DESIGN: BMJ	JOB NO.: 24-0106
DRAWN: BMJ	SHEET NO.:
CHECKED: JBA	BA LAND PROFESSIONALS
	1 OF 9



STOIC PROPERTIES
 NEWPORT VILLAGE SECTION 5
 SECTION 28, TOWNSHIP 11, RANGE 21
 CITY OF GROVEPORT
 FRANKLIN COUNTY, OH
 CONTAINING - 2.1489 TOTAL ACRES
 JULY 2024

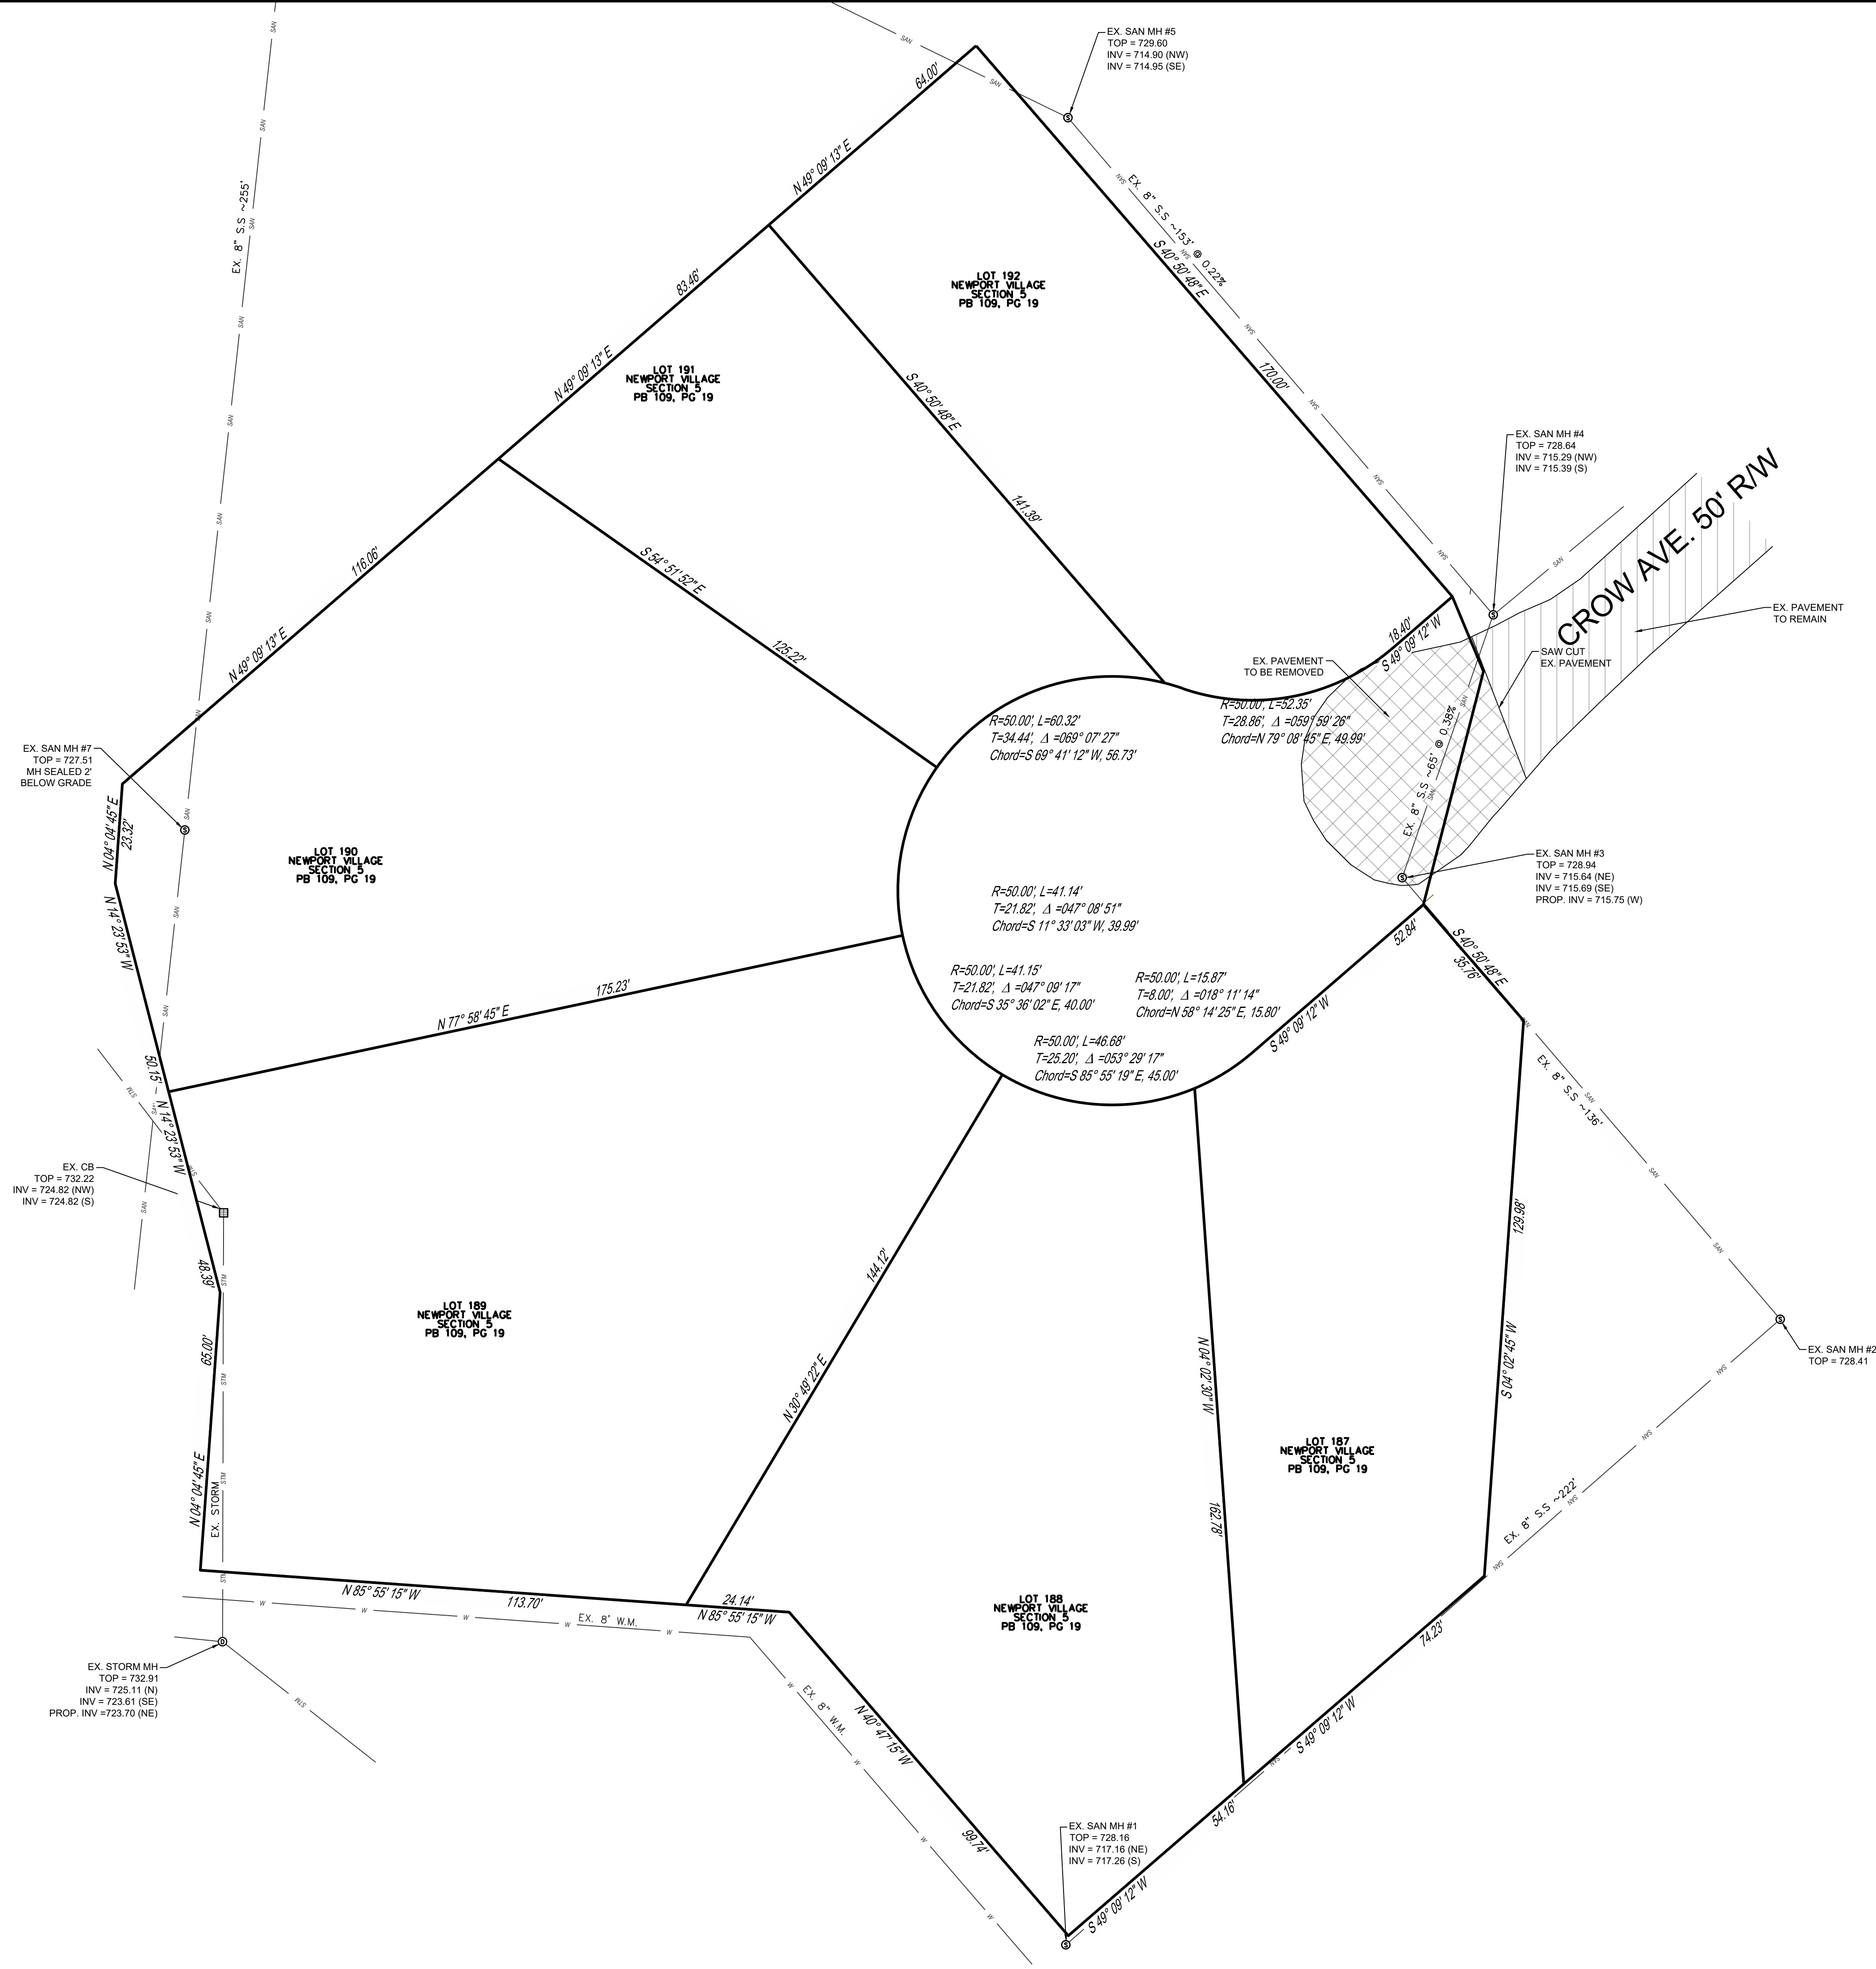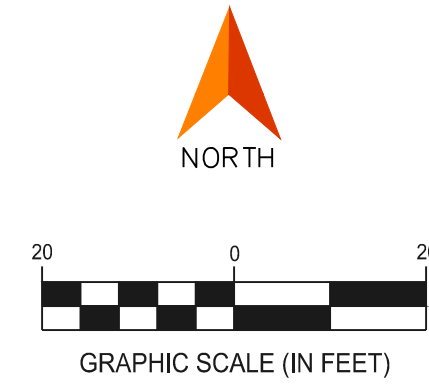

EX. CONDITION & DEMO PLAN		
NEWPORT VILLAGE SECTION 5		
CROW AVE CITY OF GROVEPORT		SECTION 28, TOWNSHIP 11, RANGE 21 FRANKLIN COUNTY, OHIO
SCALE: 1" = 20'		DATE: 06/10/2024 REV 07/15/2024
DESIGN: BMJ		JOB NO.: 24-0106
DRAWN: BMJ		SHEET NO.:
CHECKED: JBA		2 OF 9

G:\SHARED DRIVES\BA LAND PROSIBA LAND SURVEYING PROJECTS\24-0106 STOIC PROPERTIES NEWPORT VILLAGE, GROVEPORT, OH\CAD\24-0106 STOIC PROPERTIES NEWPORT VILLAGE_CIVIL SITE DESIGN - REV1.DWG - 7/15/2024 1:46 PM


STOIC PROPERTIES
 NEWPORT VILLAGE SECTION 5
 SECTION 28, TOWNSHIP 11, RANGE 21
 CITY OF GROVEPORT
 FRANKLIN COUNTY, OH
 CONTAINING - 2.1489 TOTAL ACRES
 JULY 2024

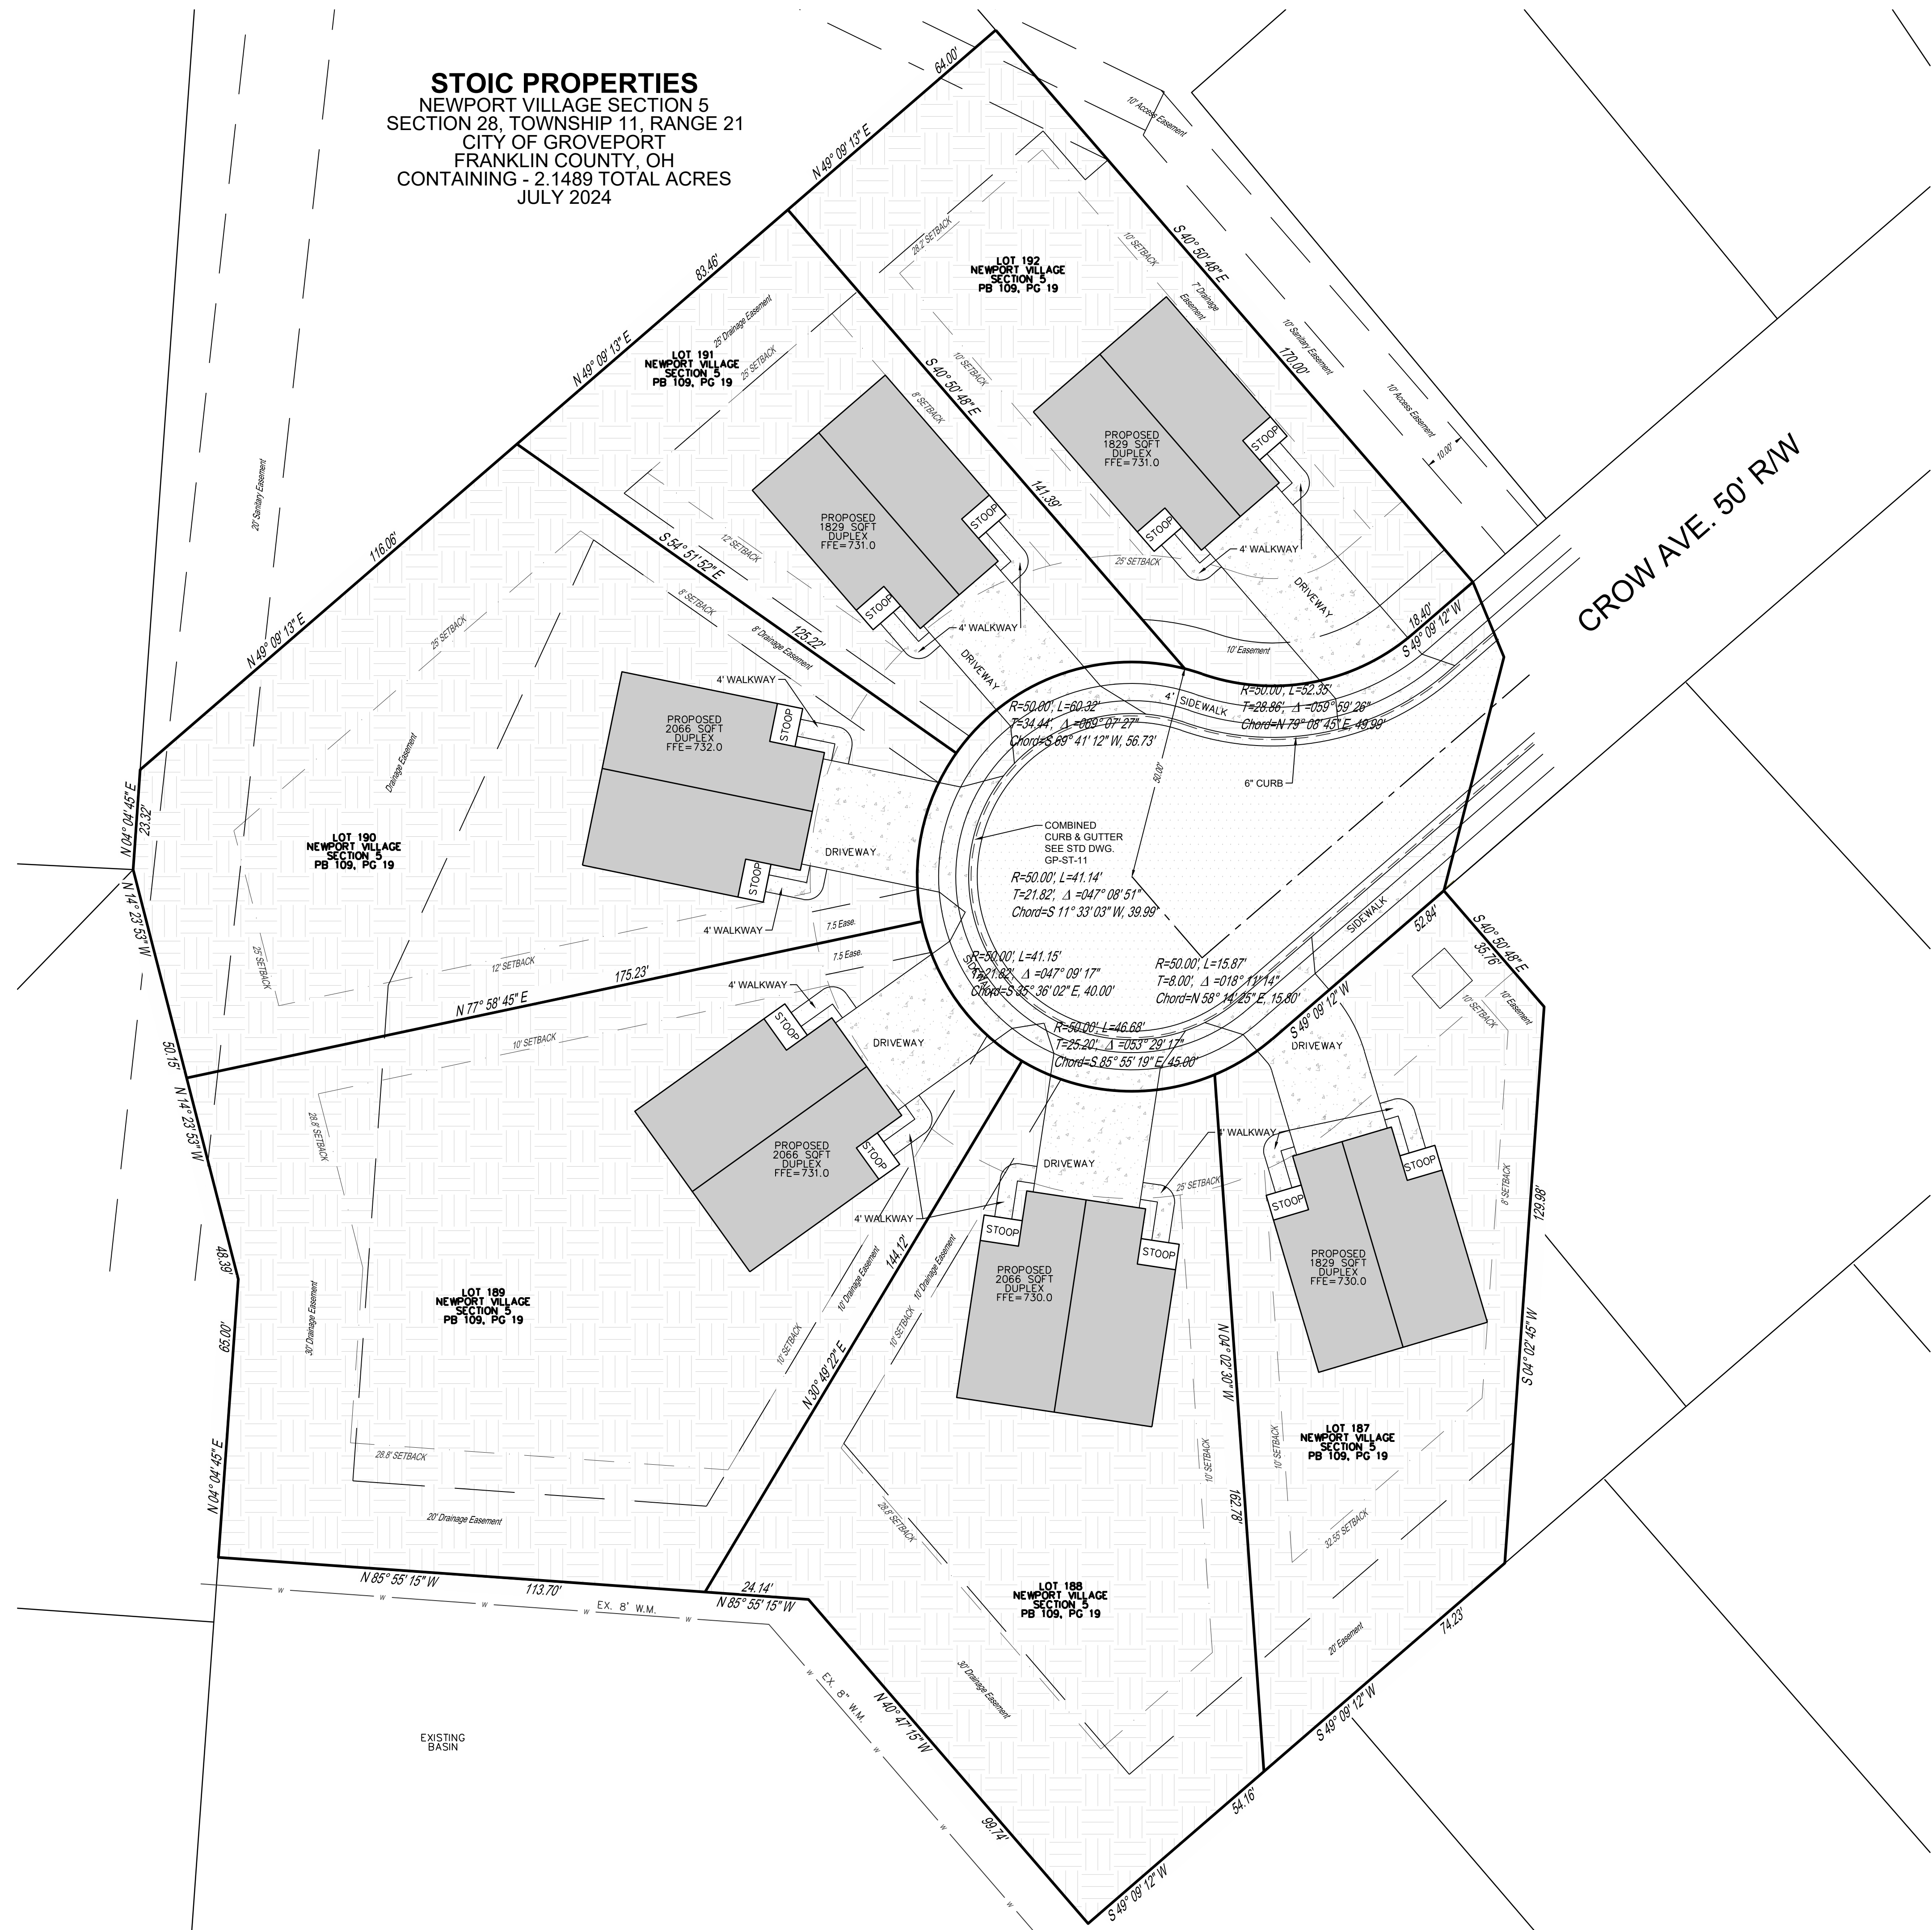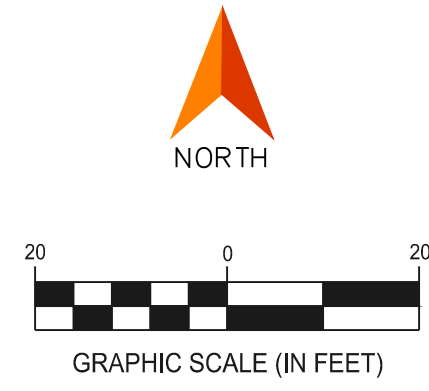


MAP LEGEND	
	BOUNDARY LINE
	LOT LINE
	EASEMENT LINE
	SETBACK LINE
	ROADWAY CENTERLINE
	BUILDING LINE
	PROPOSED CONCRETE
	PROPOSED ASPHALT
	PROPOSED LAWN

SITE LAYOUT PLAN	
NEWPORT VILLAGE SECTION 5	
CROW AVE CITY OF GROVEPORT	SECTION 28, TOWNSHIP 11, RANGE 21 FRANKLIN COUNTY, OHIO
SCALE: 1" = 20'	DATE: 06/10/2024 REV 07/15/2024
DESIGN: JBA	JOB NO.: 24-0106
DRAWN: BMJ	SHEET NO.:
CHECKED: JBA	3 OF 9



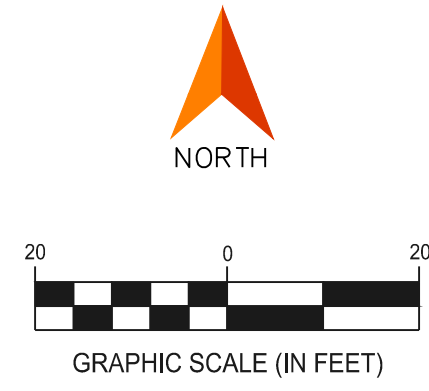

STOIC PROPERTIES
 NEWPORT VILLAGE SECTION 5
 SECTION 28, TOWNSHIP 11, RANGE 21
 CITY OF GROVEPORT
 FRANKLIN COUNTY, OH
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 JULY 2024

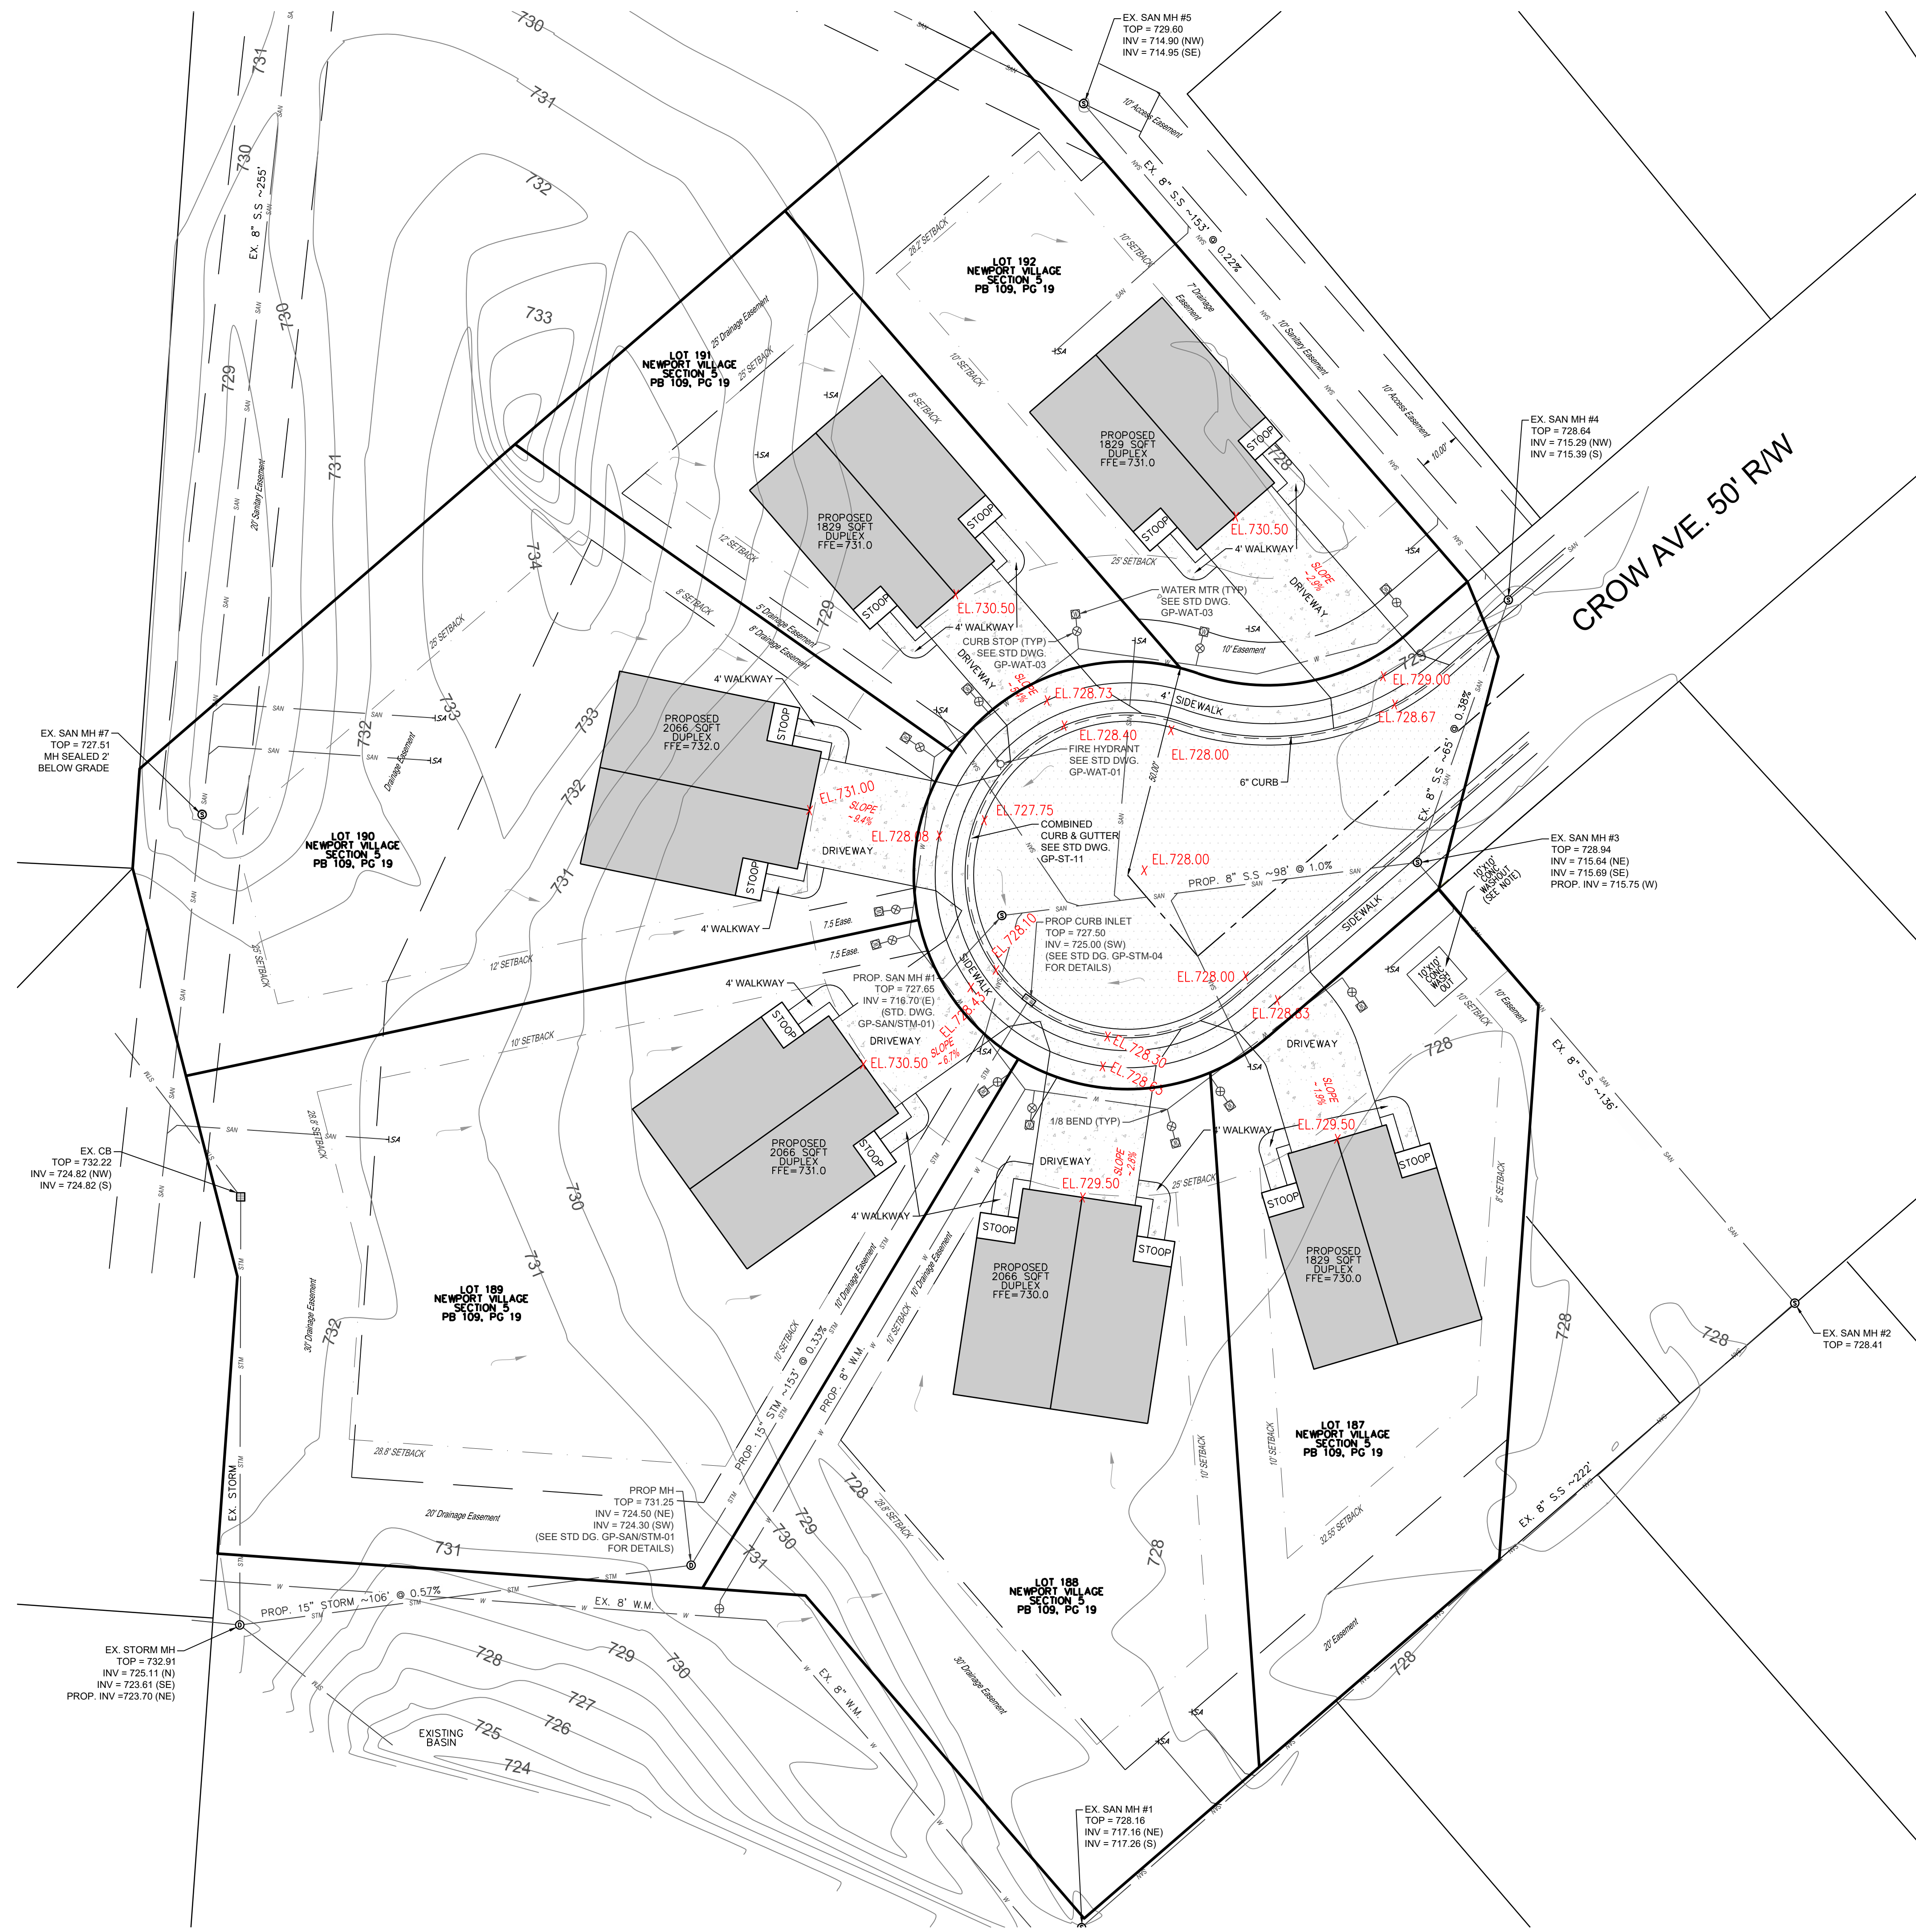

CROW AVE. 50' R/W

SITE GRADING & UTILITY PLAN






NEWPORT VILLAGE SECTION 5

CROW AVE CITY OF GROVEPORT SECTION 28, TOWNSHIP 11, RANGE 21 FRANKLIN COUNTY, OHIO


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DRAWN: BMJ		SHEET NO.:
CHECKED: JBA		4 OF 9

STOIC PROPERTIES
 NEWPORT VILLAGE SECTION 5
 SECTION 28, TOWNSHIP 11, RANGE 21
 CITY OF GROVEPORT
 FRANKLIN COUNTY, OH
 CONTAINING - 2.1489 TOTAL ACRES
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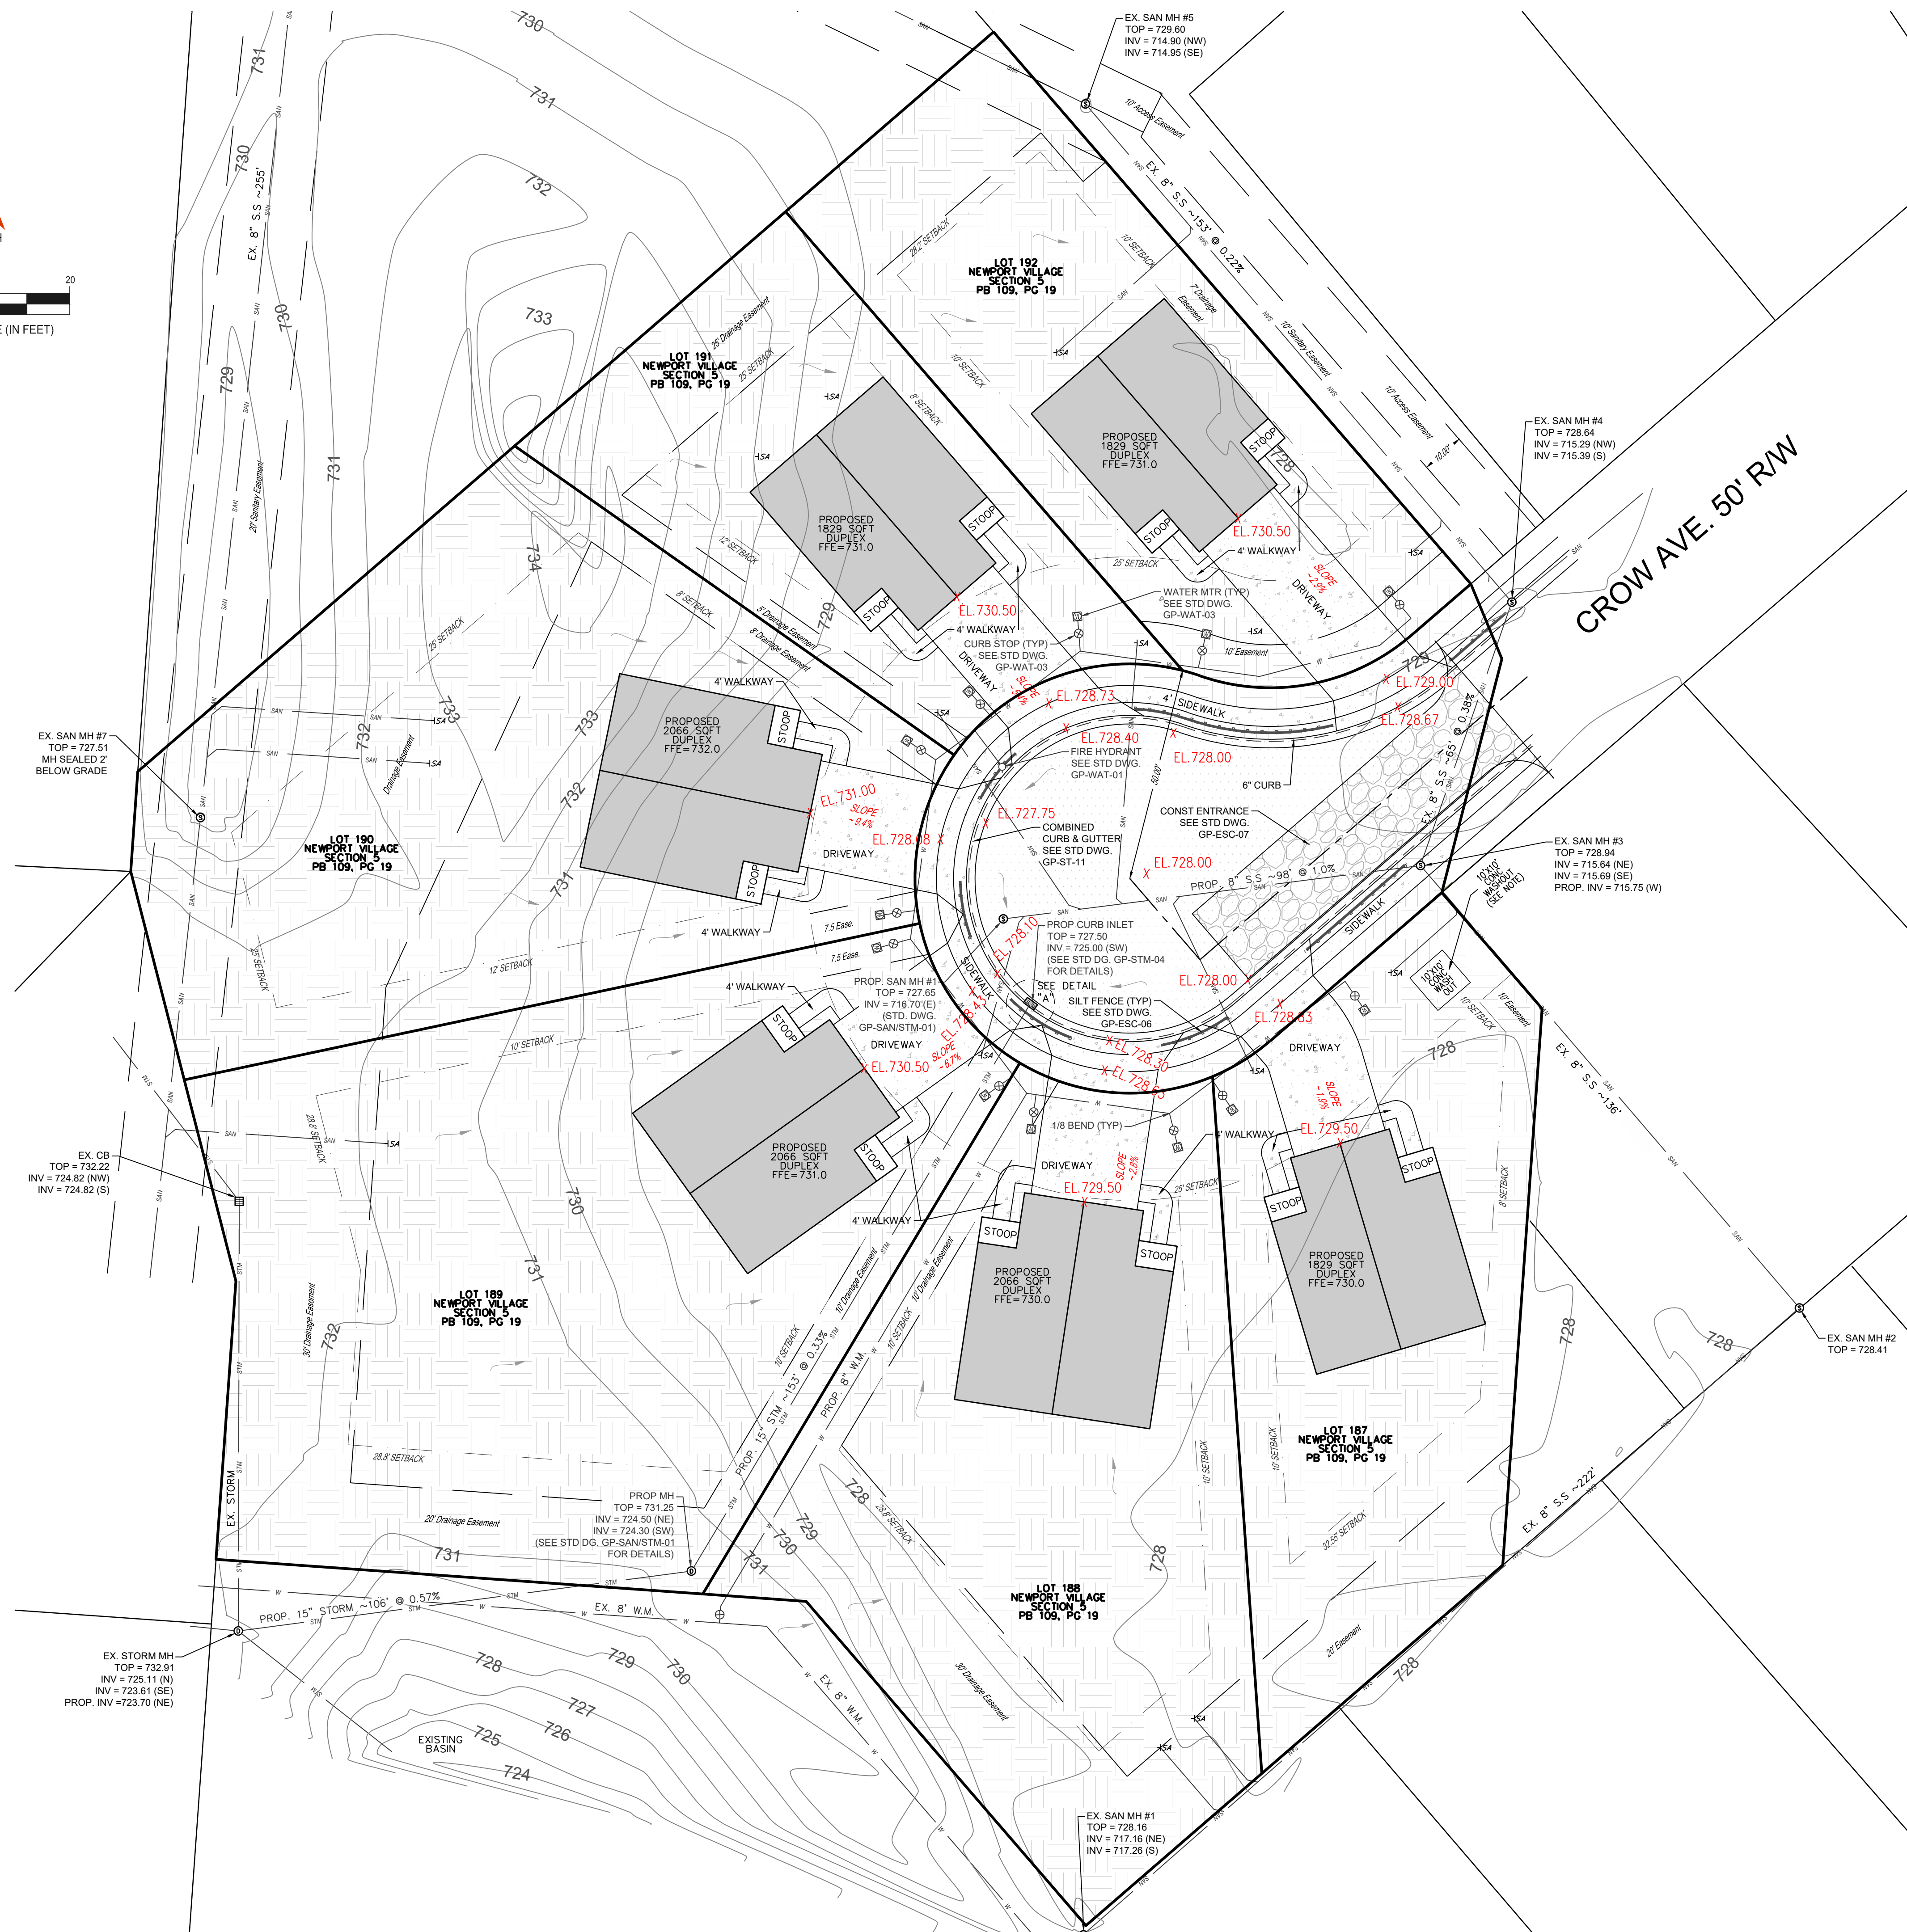
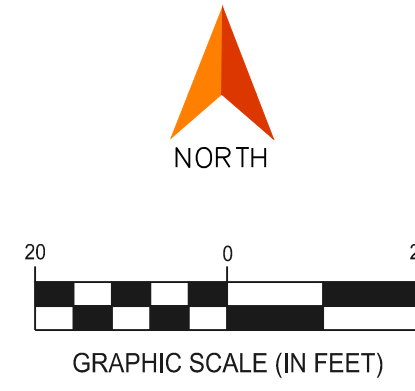
STORM PROFILE LOOKING NORTH-WEST

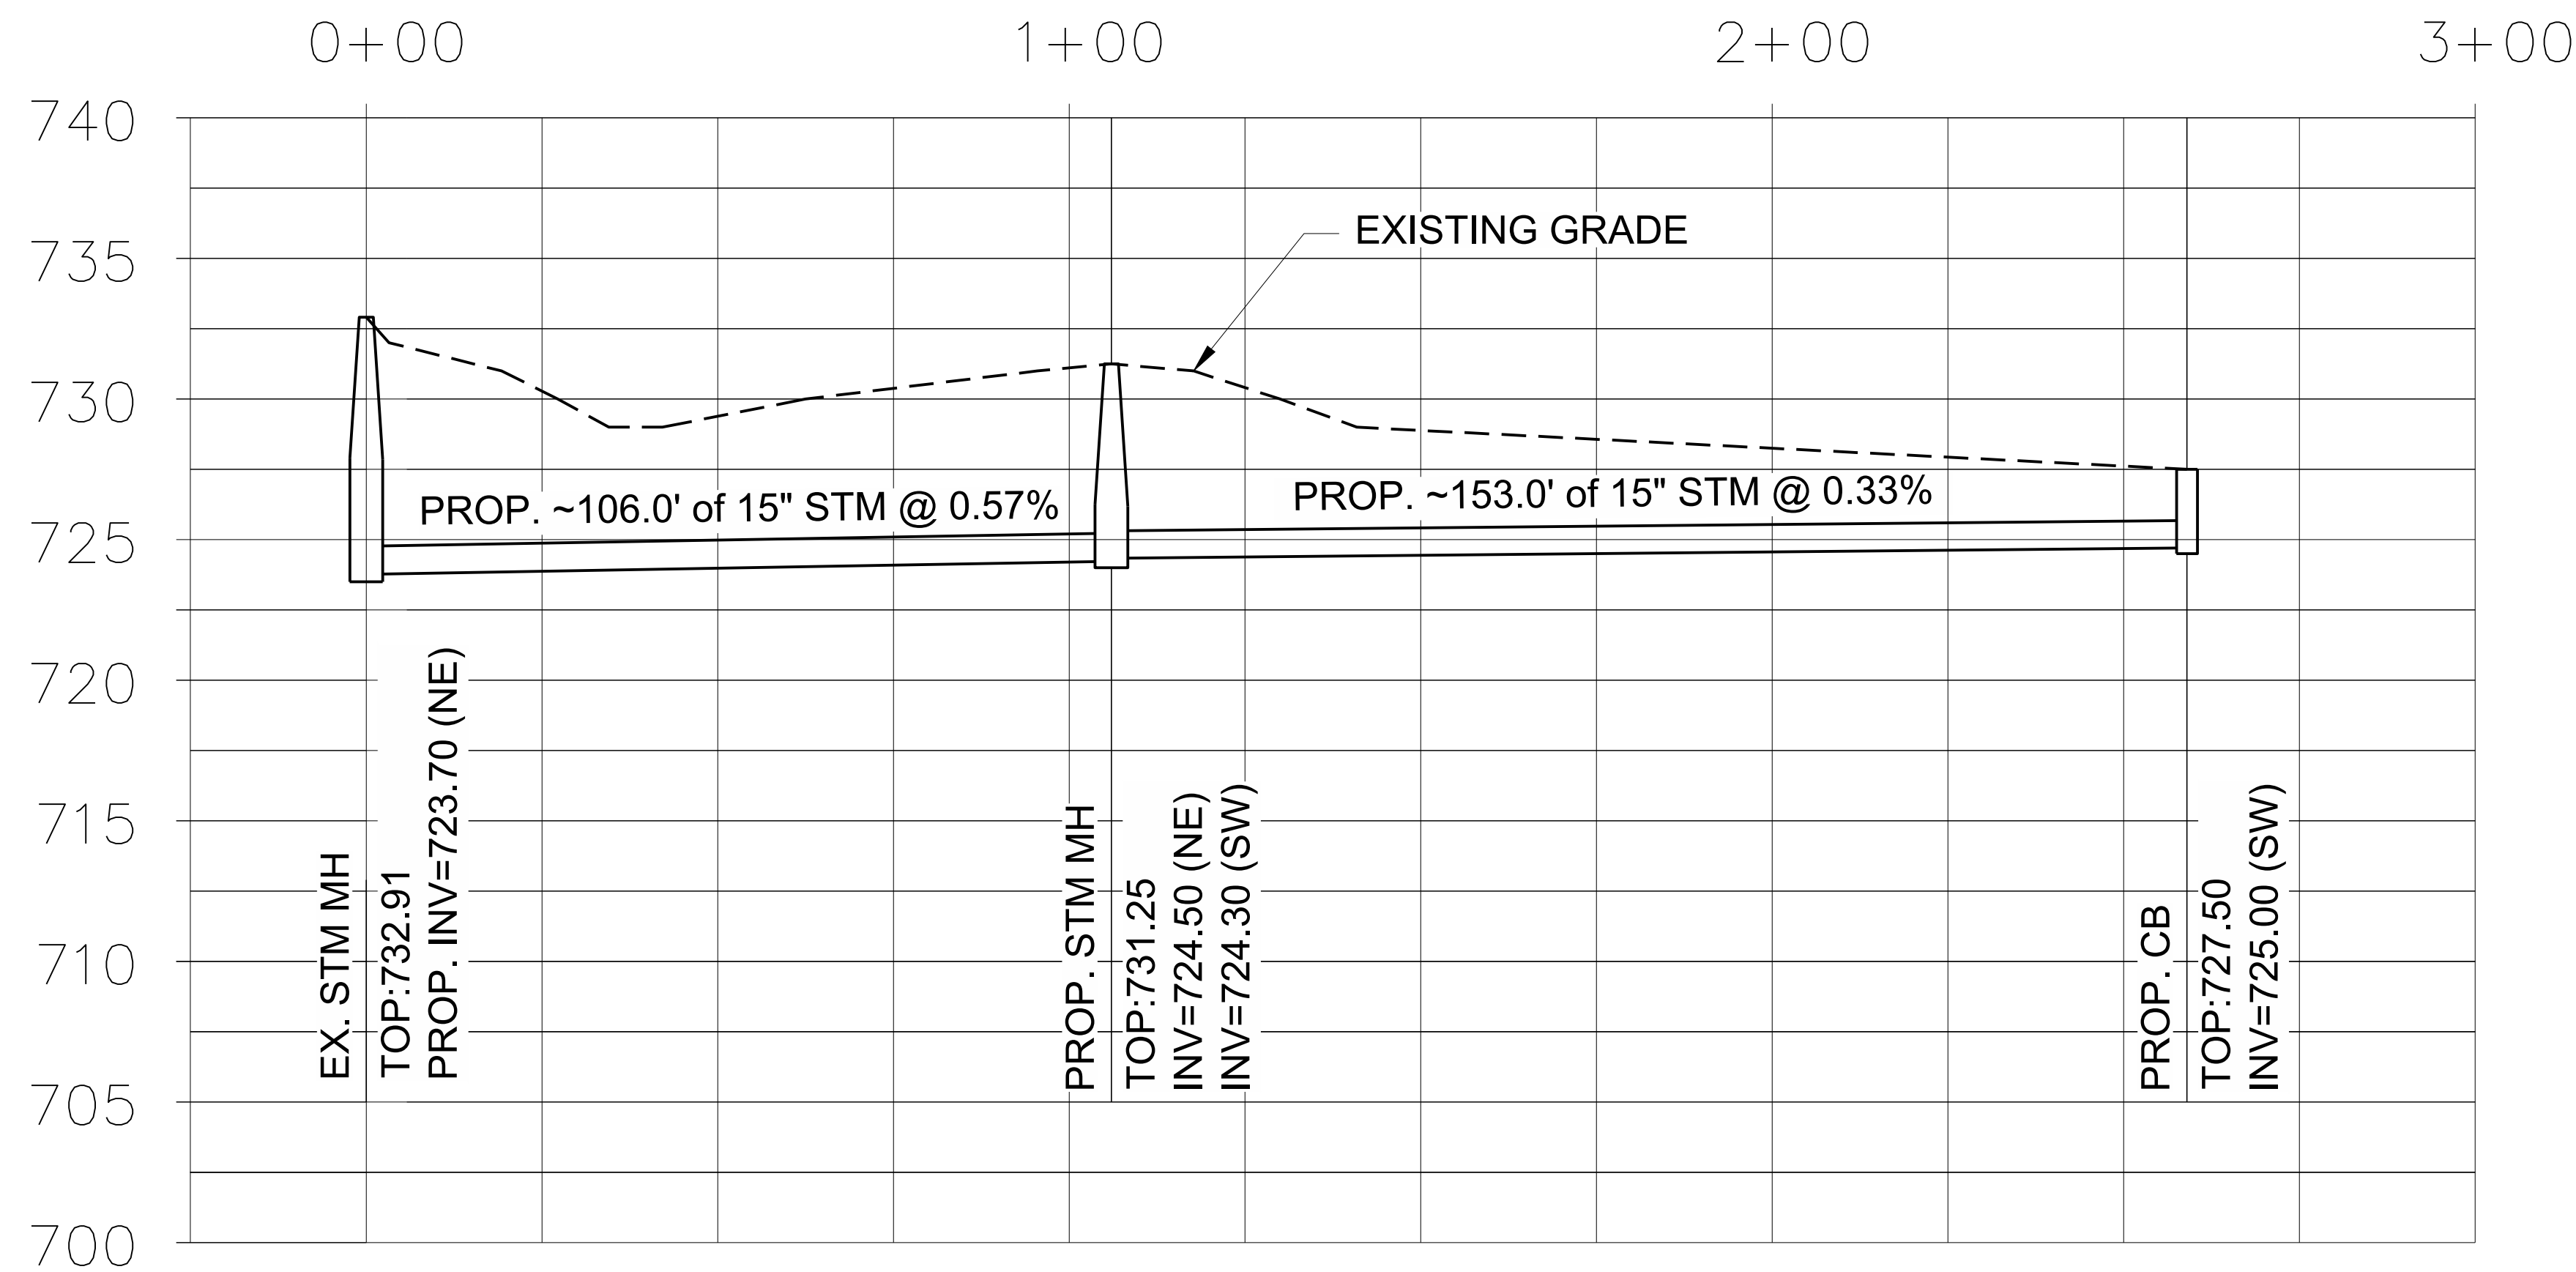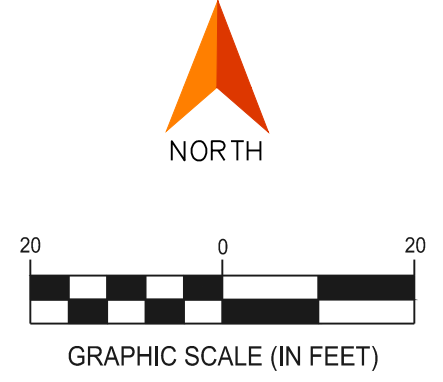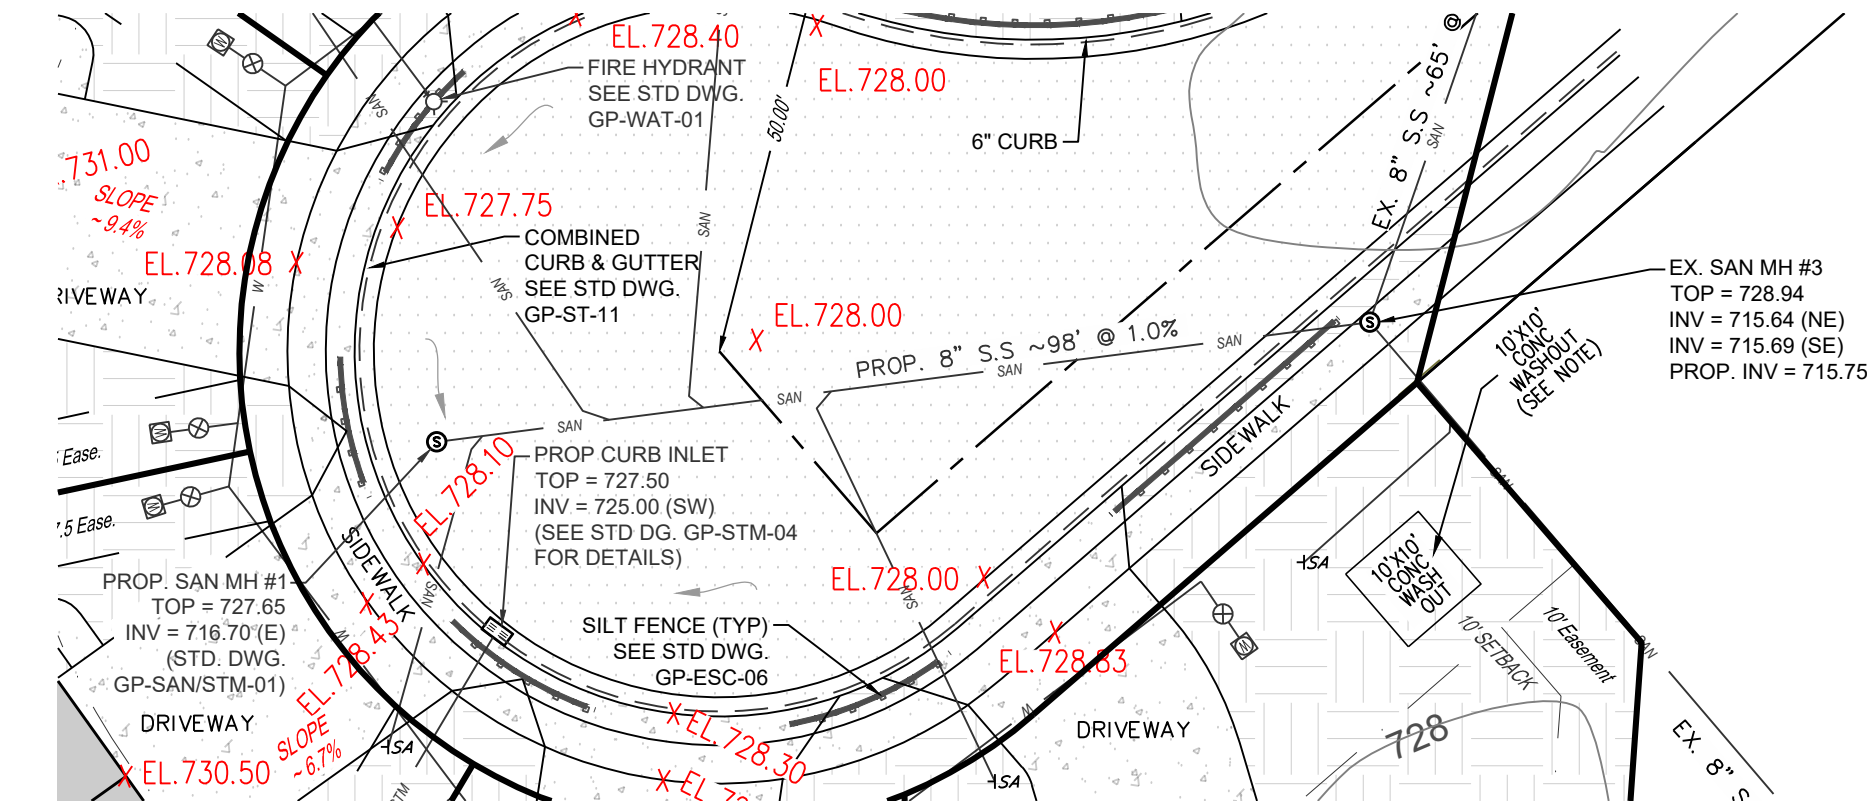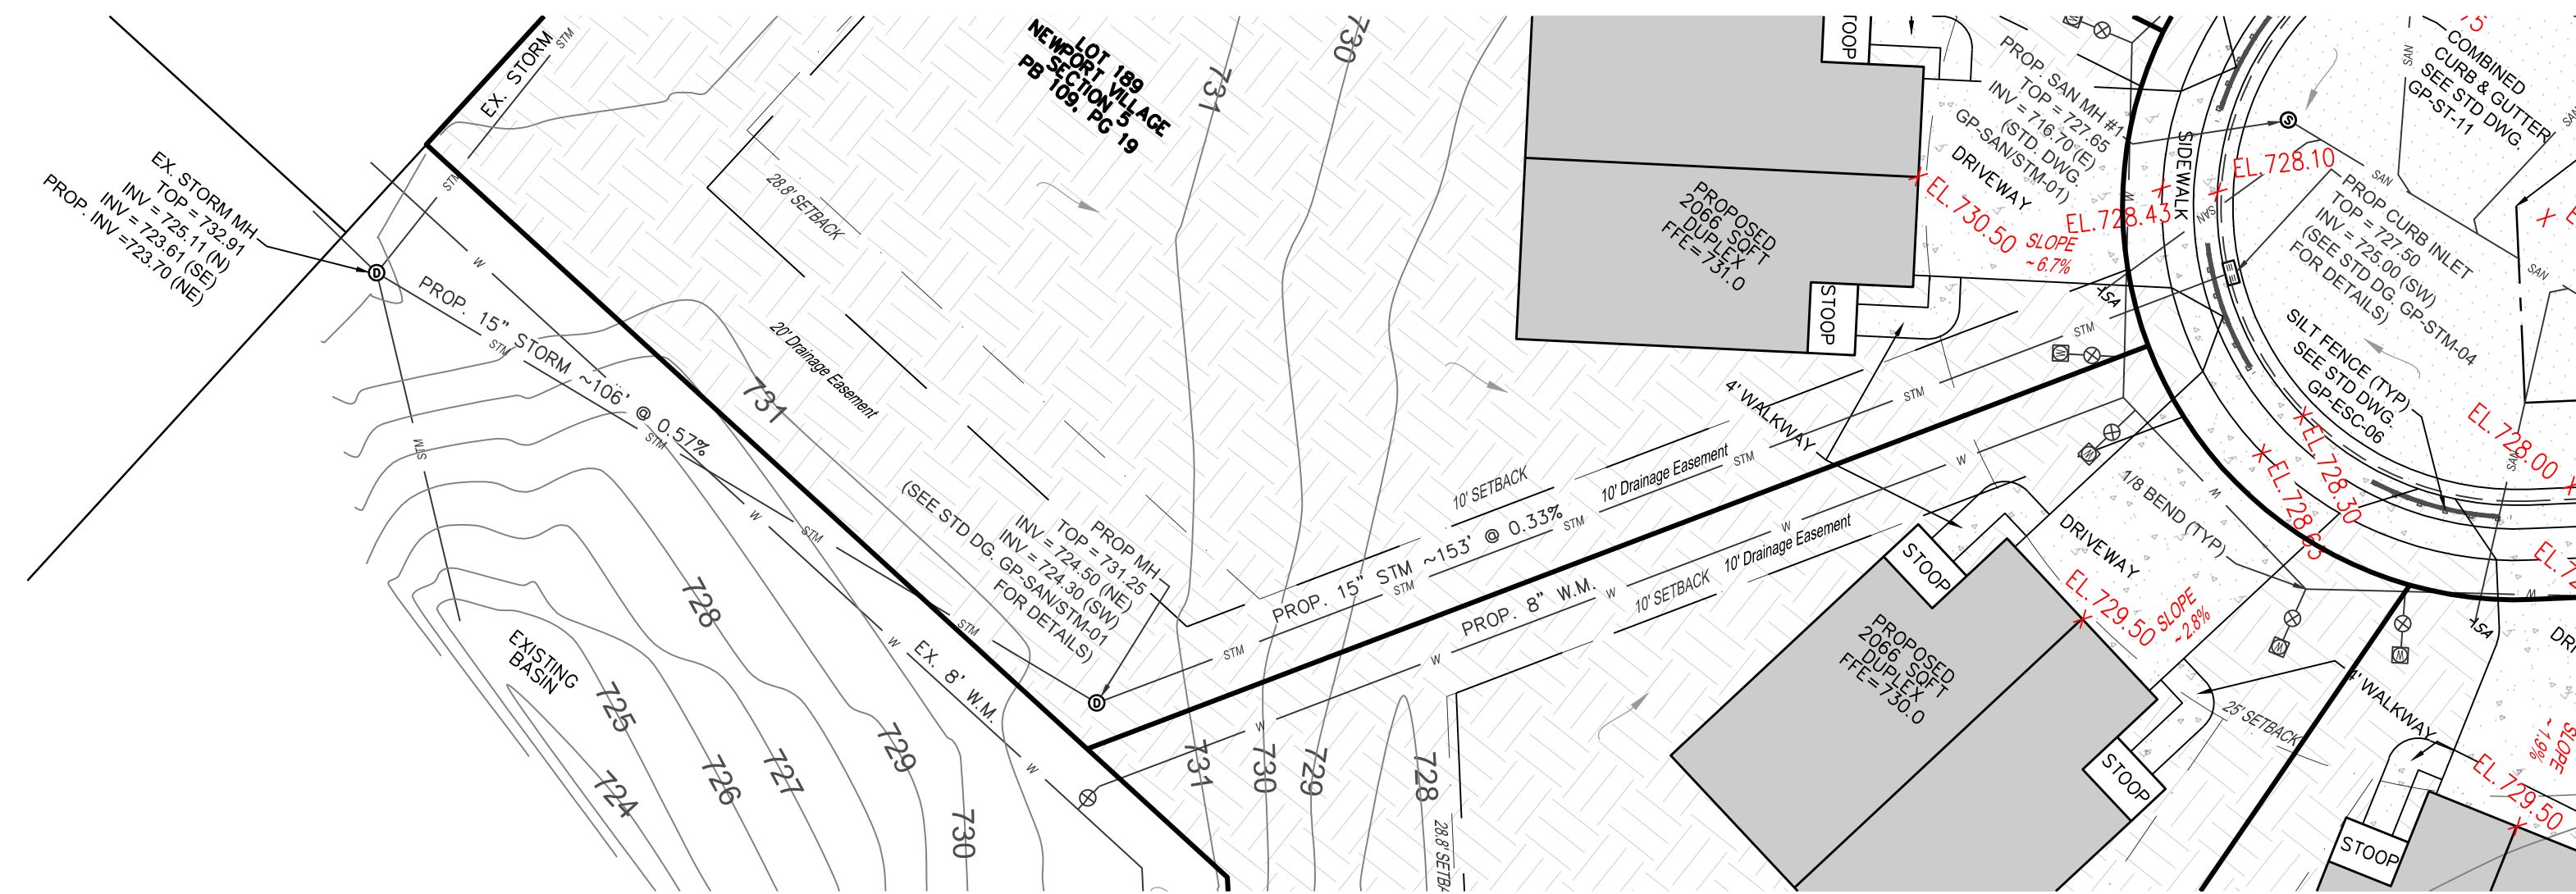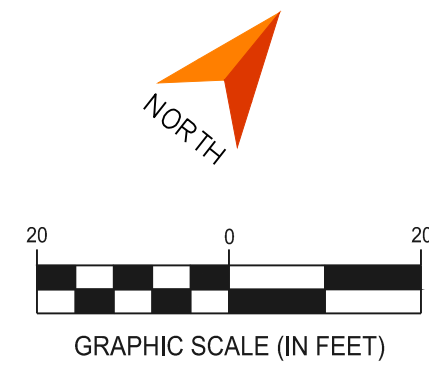

SAN PROFILE LOOKING NORTH

UTILITY PROFILES	
NEWPORT VILLAGE SECTION 5	
CROW AVE CITY OF GROVEPORT	SECTION 28, TOWNSHIP 11, RANGE 21 FRANKLIN COUNTY, OHIO
SCALE: 1" = 20'	DATE: 06/10/2024 REV 07/15/2024
DESIGN: BMJ	JOB NO.: 24-0106
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STOIC PROPERTIES
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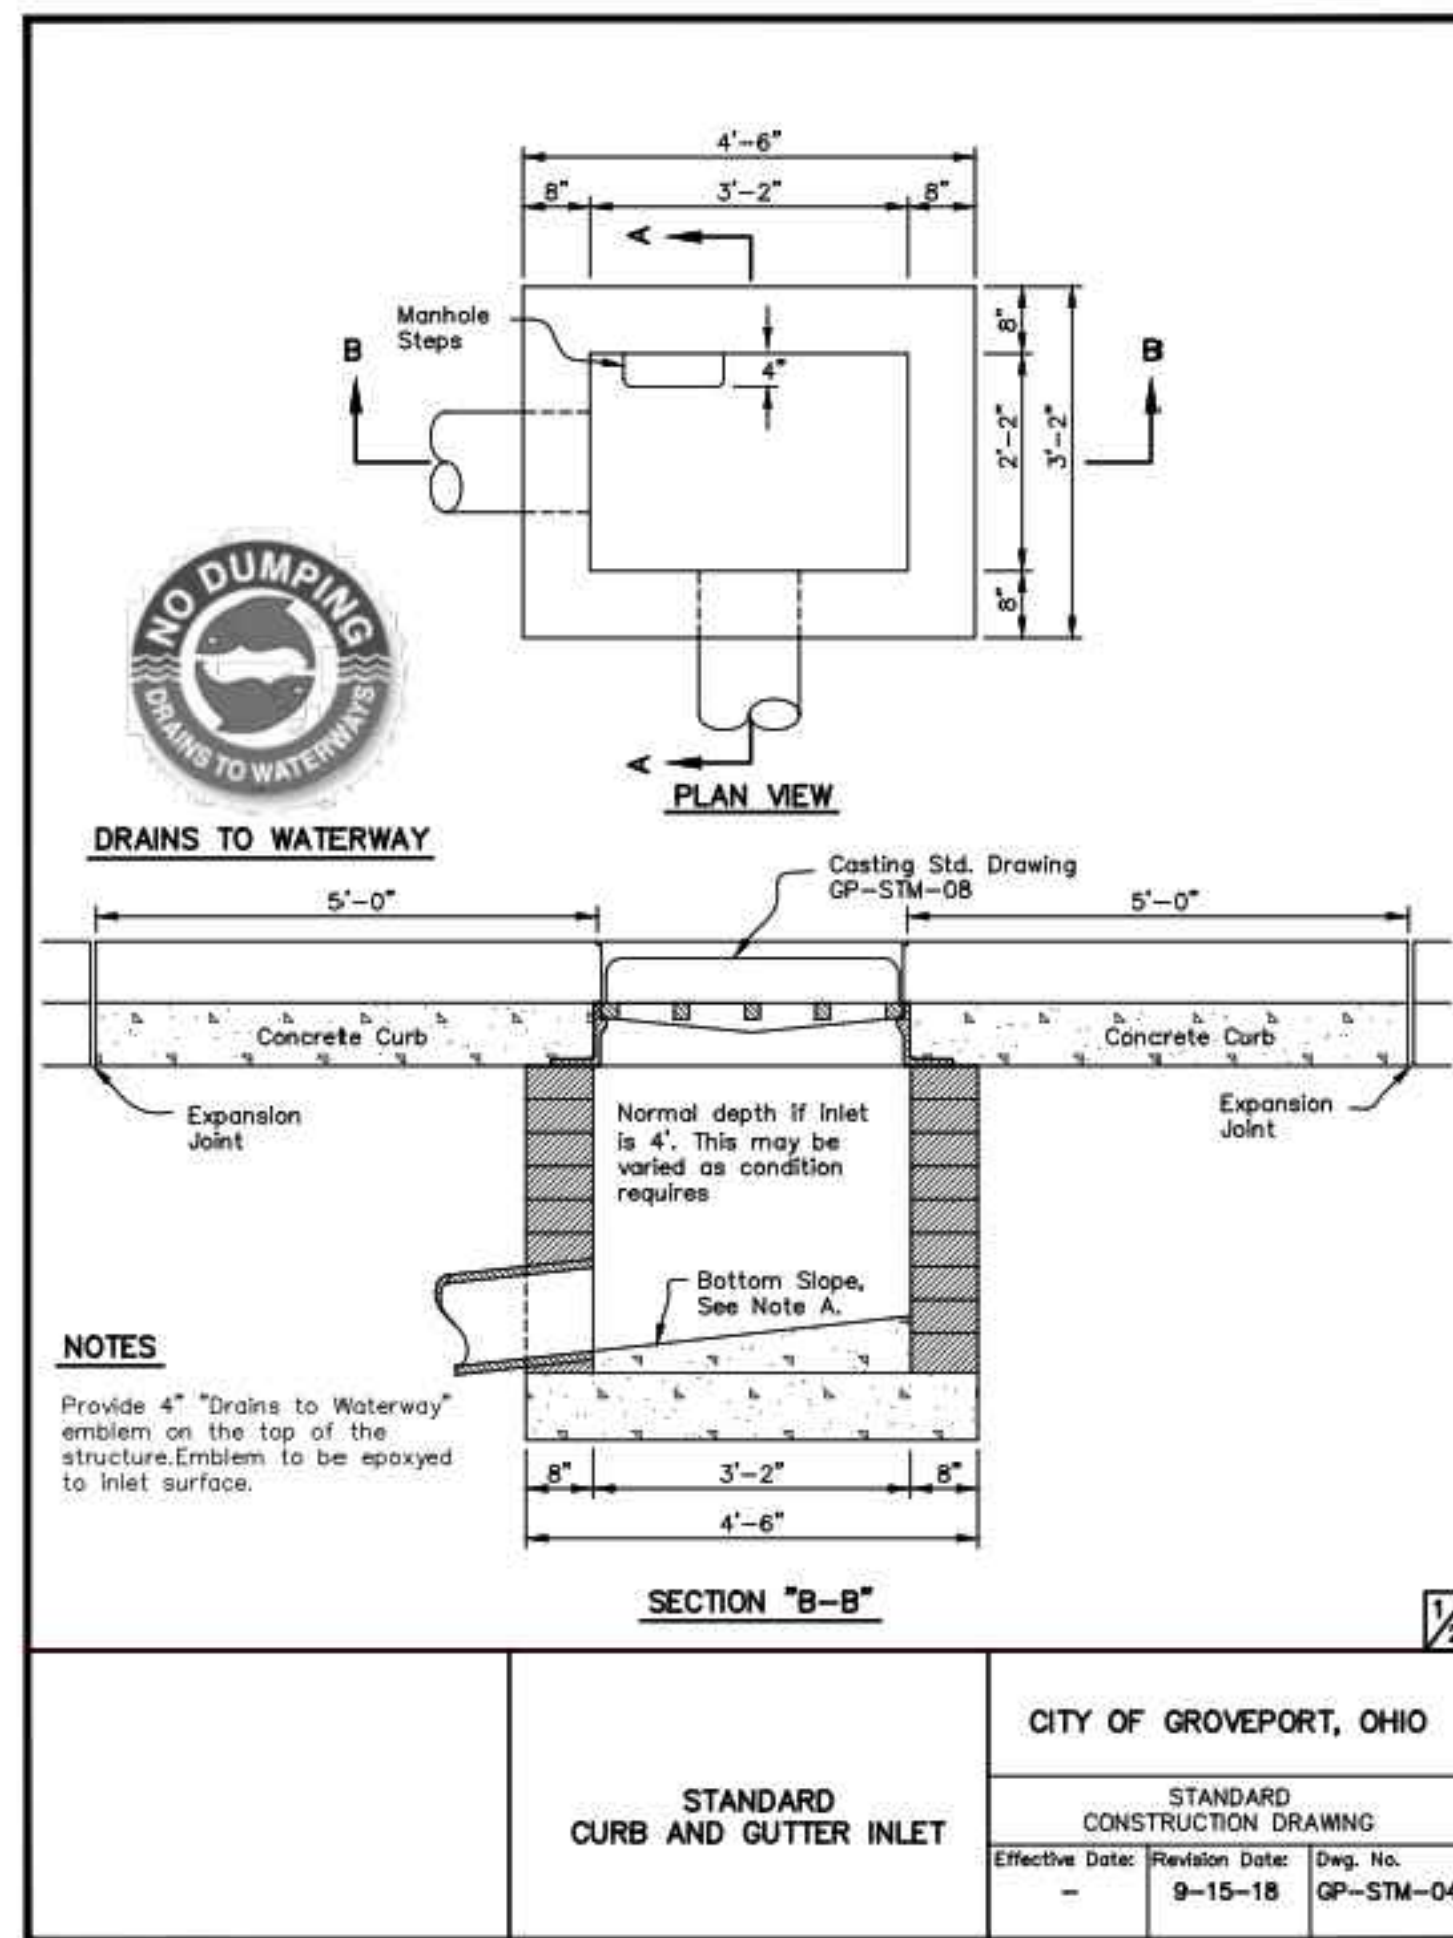


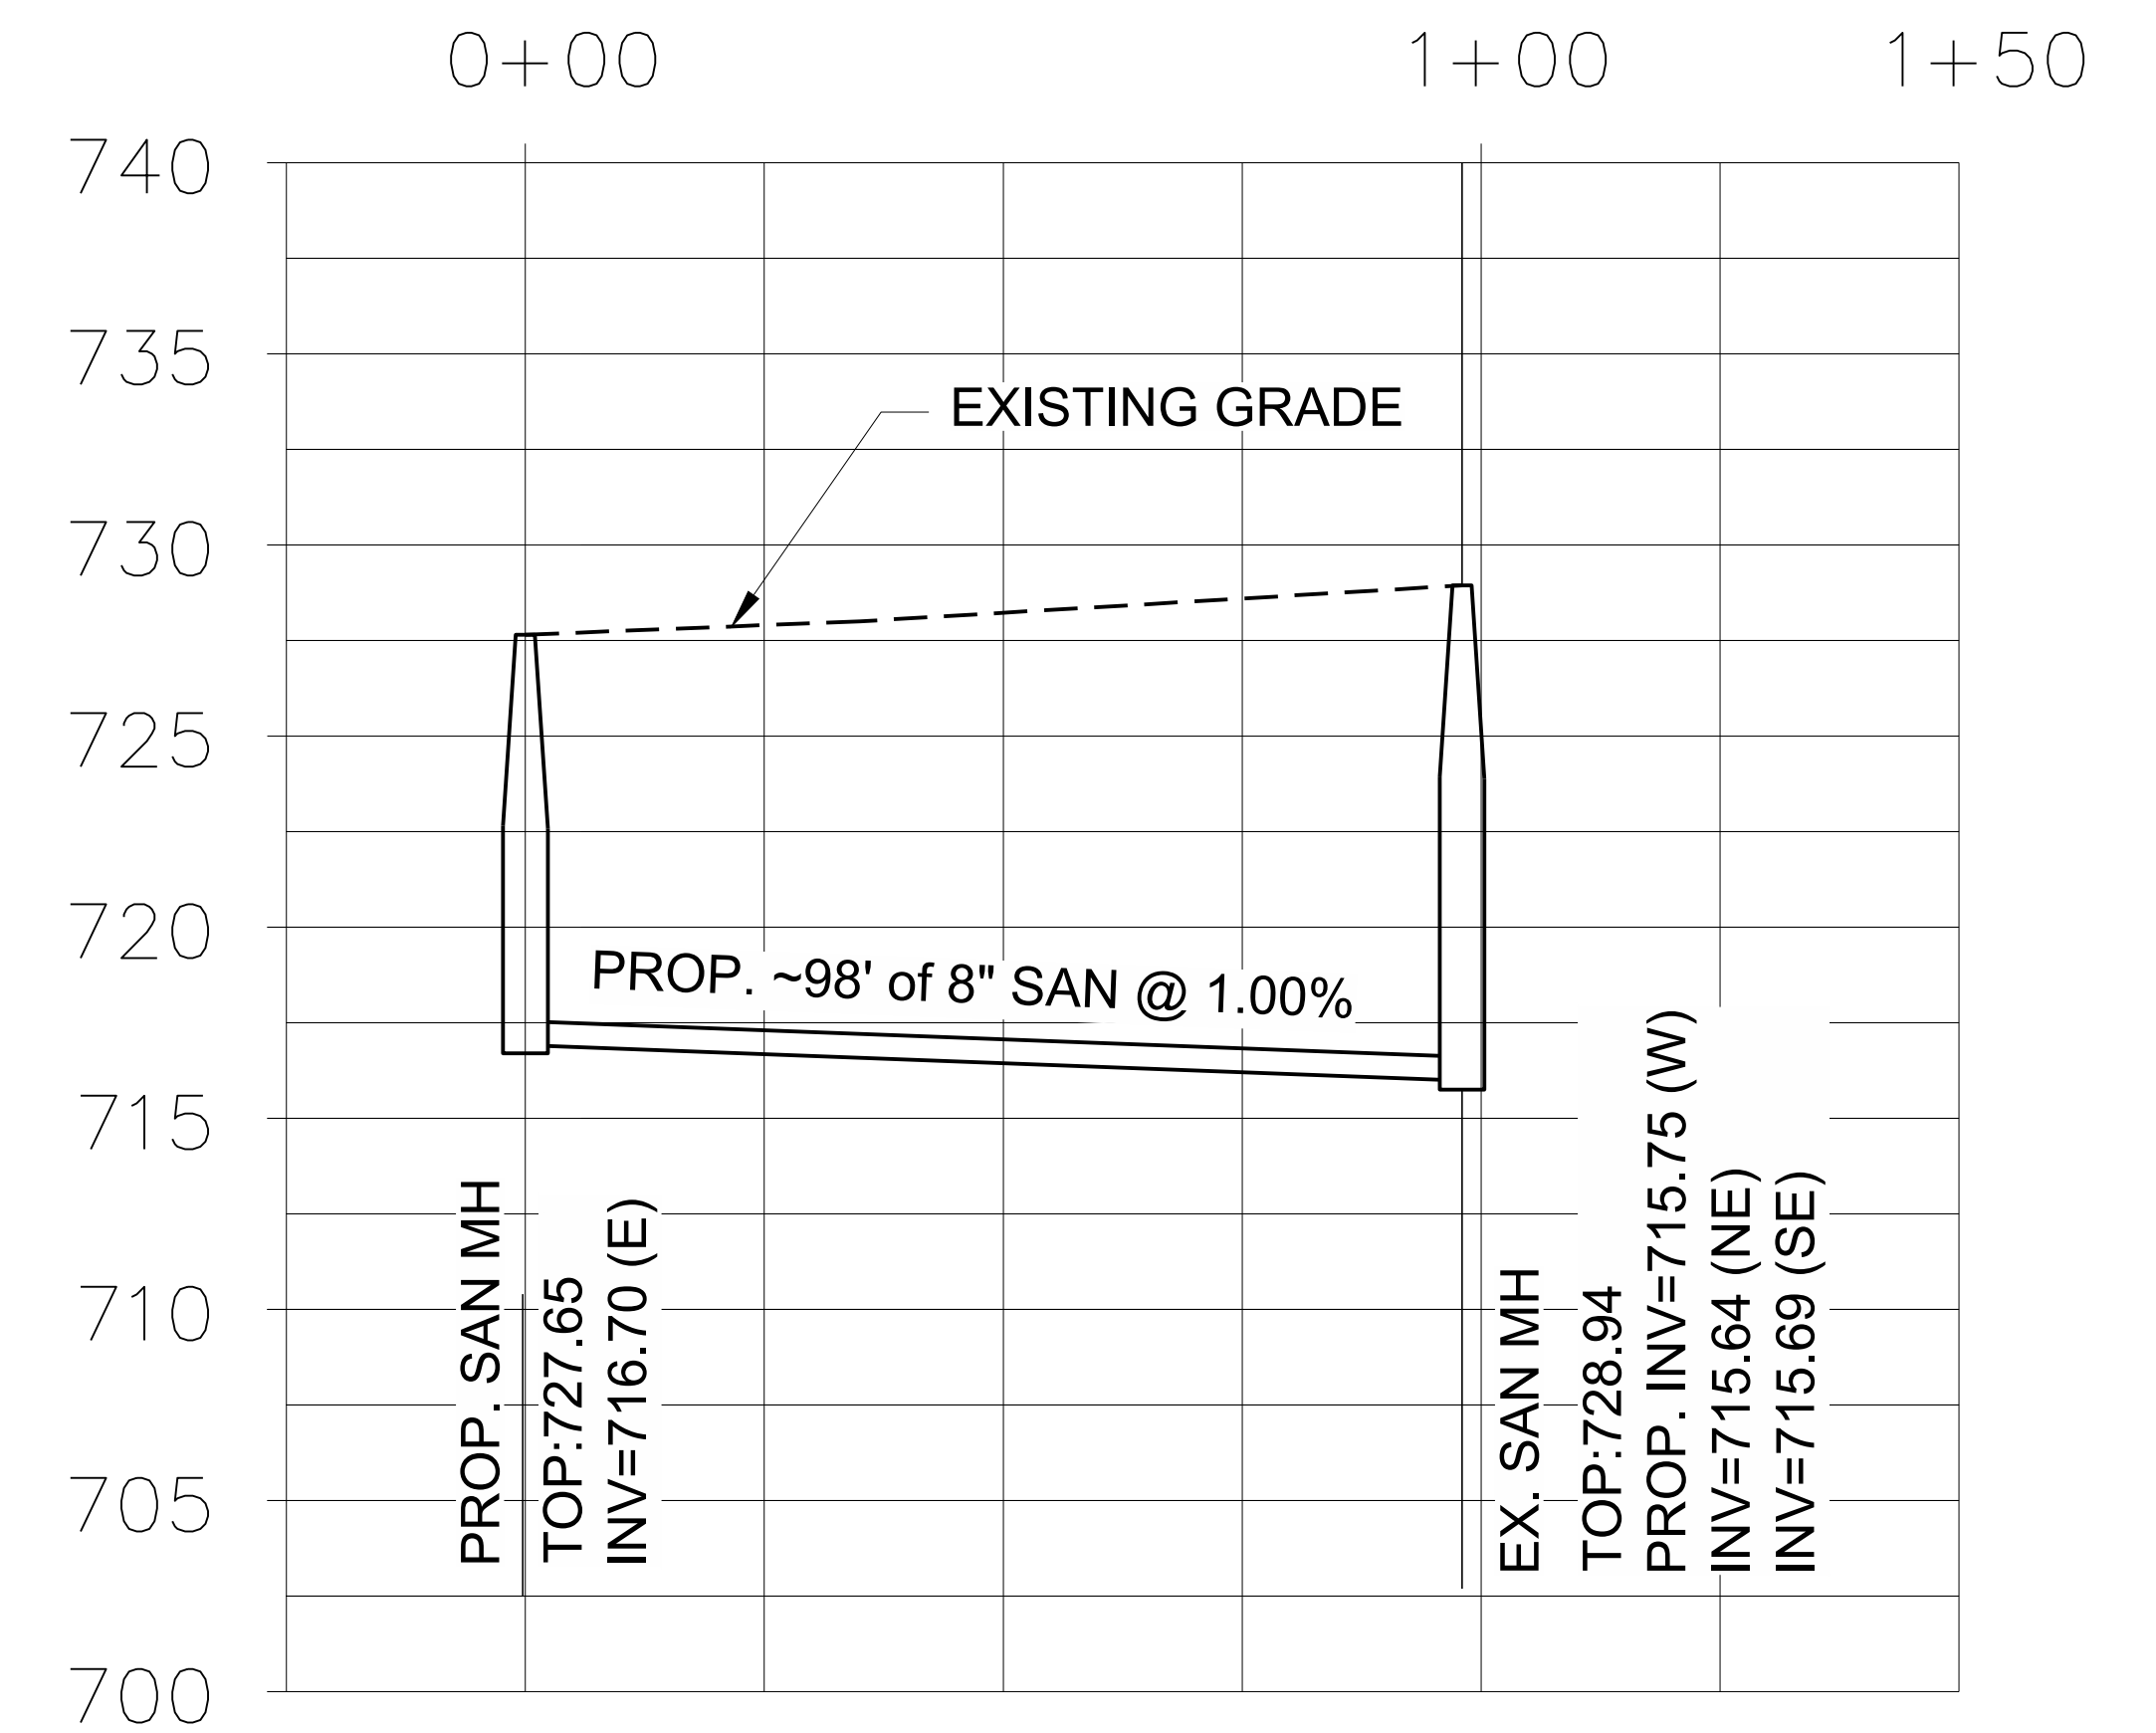DETAIL "A"
 DANDY CURB BAG
 OR EQUIVALENT
 SEE STD DWG GP-ESC-03


WATER QUALITY VOLUME (WQ_v)
 WATER QUALITY VOLUME WILL BE CALCULATED USING OHIO EPA FORMULA
 $WQ_v = R_v \times P \times A / 12$
 WHERE R_v = VOLUMETRIC RUNOFF COEFFICIENT = 0.05+0.9*i*;
 WHERE i = FRACTION OF POST CONSTRUCTION IMPERVIOUS SURFACE
 TOTAL BMP AREA = 2,1489 AC = 93,606 SF
 POST CONSTRUCTION IMPERVIOUS AREA = 26,004 SF
 $R_v = 0.05 + 0.9 \times (26004/93606) = 0.30$
 $WQ_v = R_v \times P \times A / 12 = 0.30 \times 0.9 \times (2.1489/12) = 0.04835$ AC-FT
 = 2,106 CF
 SEDIMENT STORAGE, 20% OF WQ_v = 421 CF
 TOTAL WATER QUALITY STORAGE VOLUME = 2,527 CF
 THIS VOLUME WILL BE ACCOMMODATED BY THE EXISTING BASIN LOCATED IN THE SOUTH.

CONCRETE WASHOUT
 CONCRETE WASHOUT SHALL BE MIN. 10'X10' IN SIZE AND SHALL BE "ABOVE GRADE" OR "BELOW GRADE" WITH 10 MIL PLASTIC LINING.
 IT SHALL BE CONSTRUCTED PER CONCRETE WASTE MANAGEMENT DESIGN STANDARDS.
 A CONC. WASHOUT SIGN SHALL BE INSTALLED WITHIN 30' OF THE WASHOUT FACILITY.


SWPPP & STORMWATER QUALITY PLAN	
NEWPORT VILLAGE SECTION 5	
CROW AVE CITY OF GROVEPORT SECTION 28, TOWNSHIP 11, RANGE 21 FRANKLIN COUNTY, OHIO	
SCALE: 1" = 20'	DATE: 06/10/2024 REV 07/15/2024
DESIGN: BMJ	JOB NO.: 24-0106
DRAWN: BMJ	SHEET NO.:
CHECKED: JBA	BA LAND PROFESSIONALS
	6 OF 9




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STANDARD CONSTRUCTION DRAWING		
Effective Date:	Revision Date:	Dwg. No.
-	9-15-18	GP-STM-04

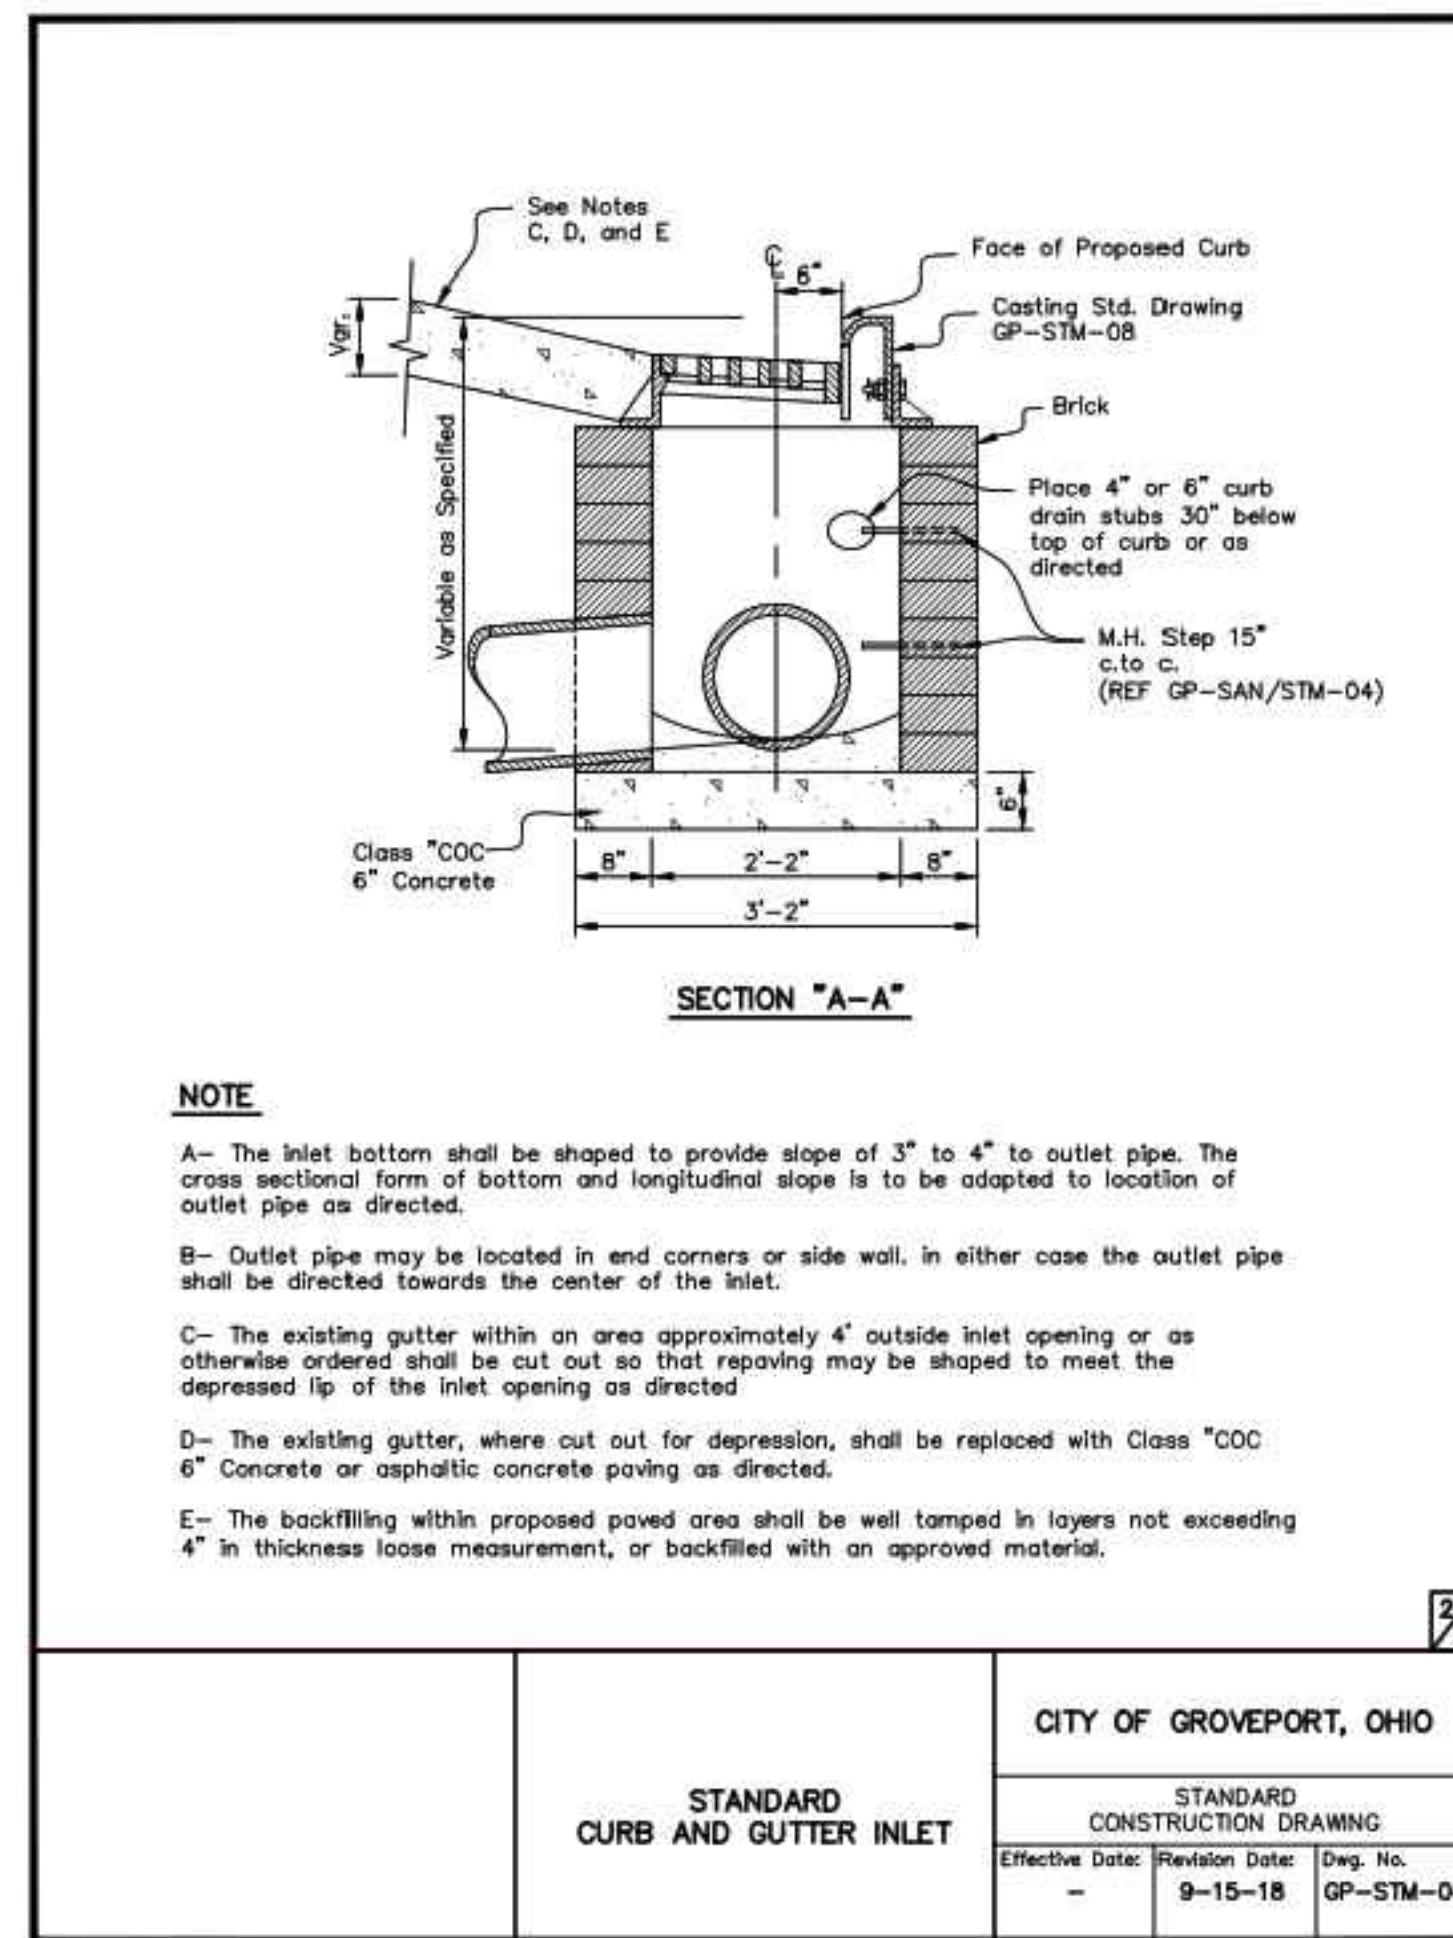


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-	9-15-18	GP-STM-04

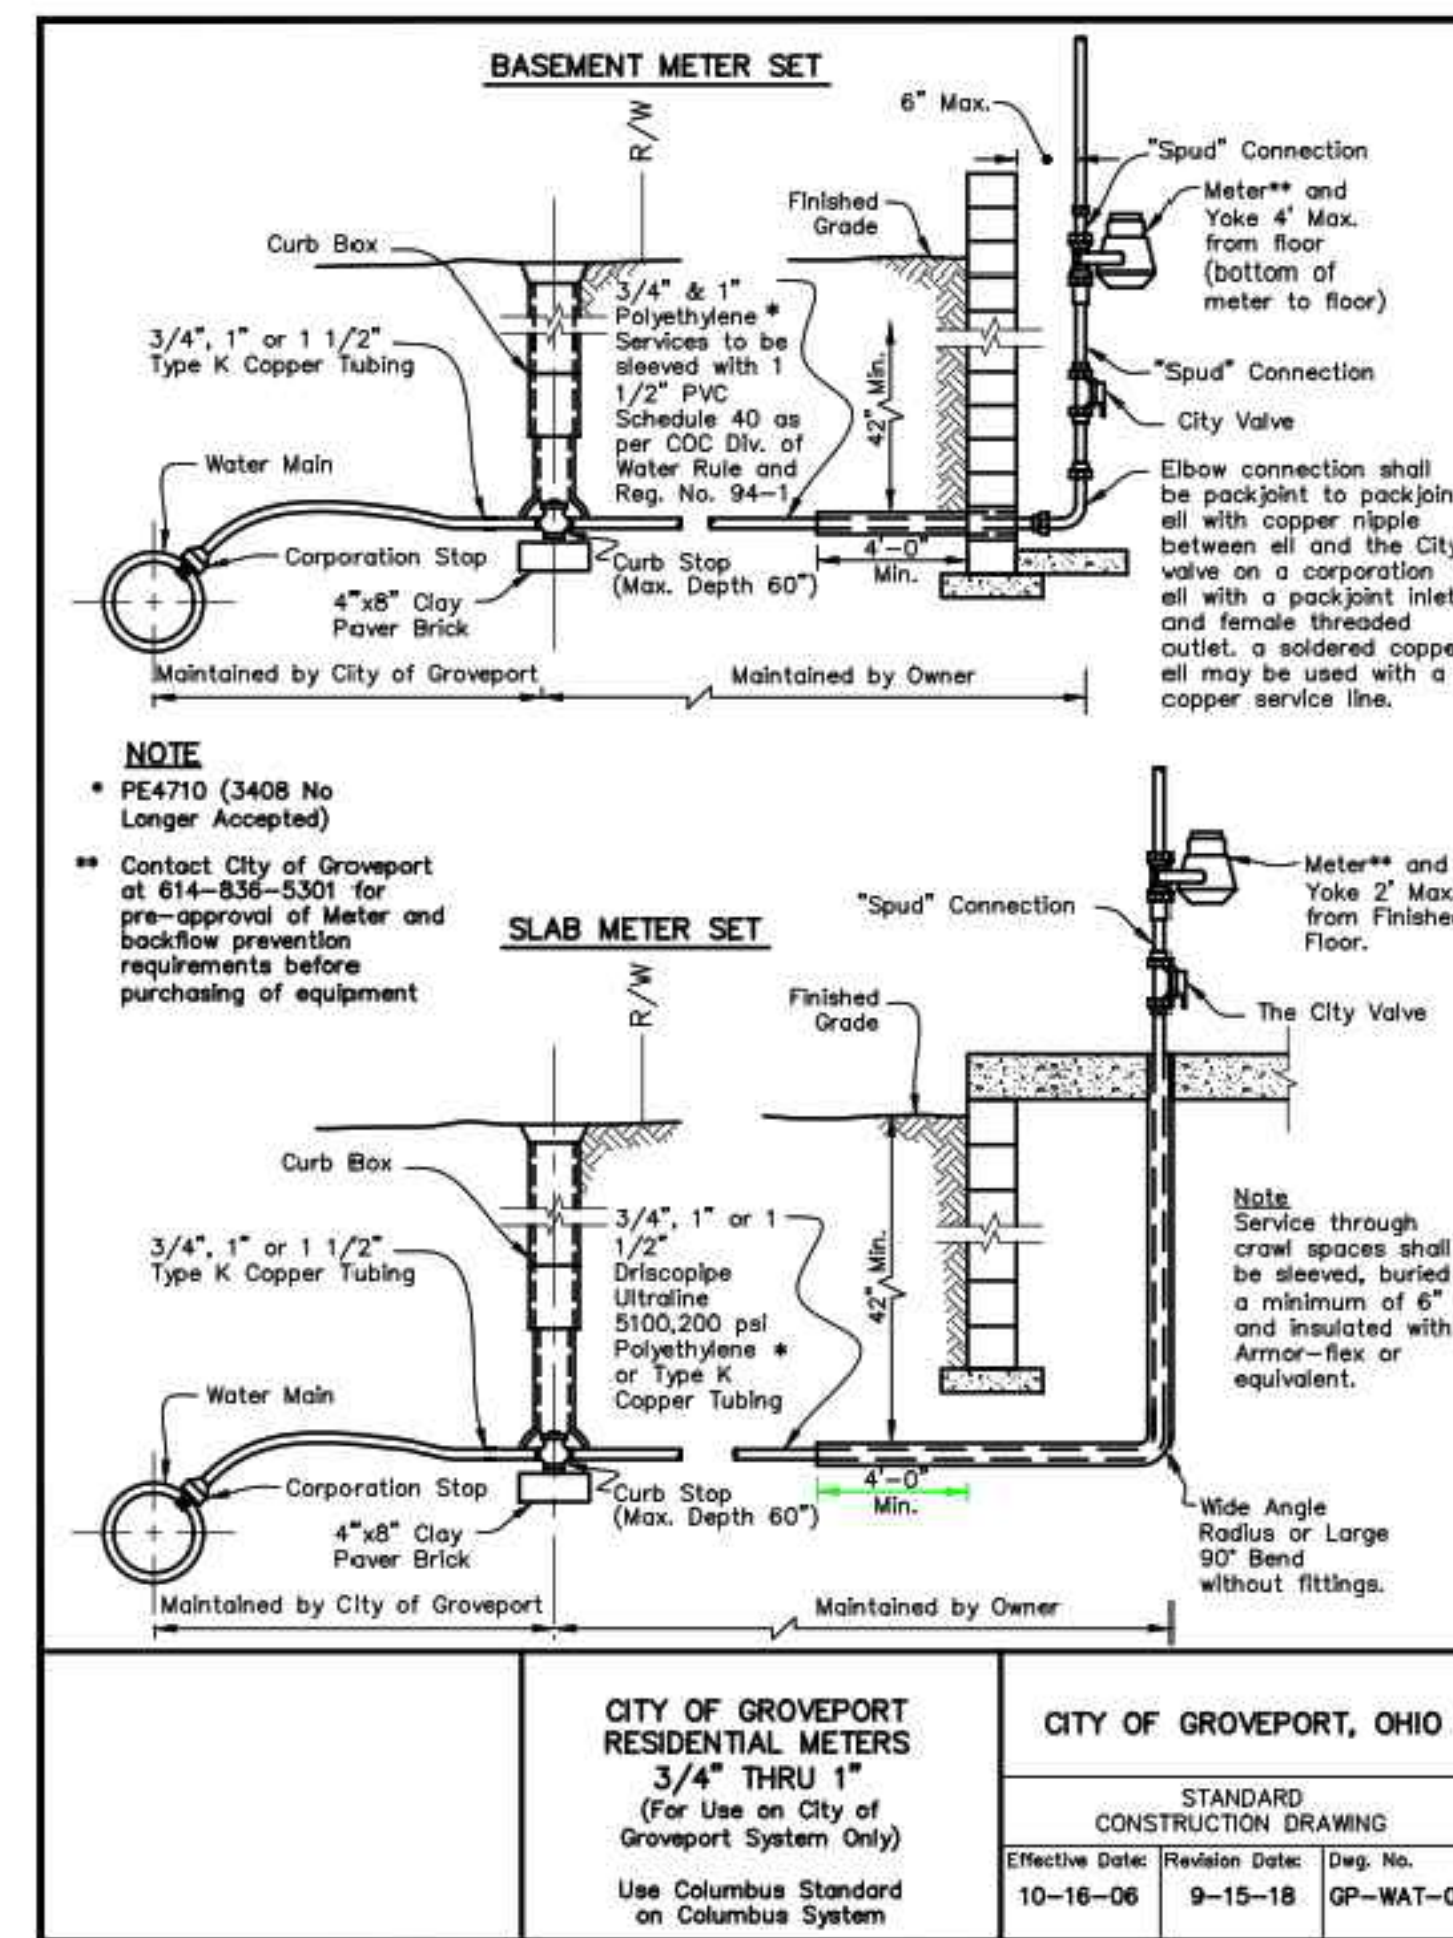


CITY OF GROVEPORT, OHIO		CITY OF GROVEPORT, OHIO	
STANDARD CONSTRUCTION DRAWING		STANDARD CONSTRUCTION DRAWING	
Effective Date:	Revision Date:	Effective Date:	Revision Date:
10-16-06	9-15-18	10-16-06	9-15-18
GP-WAT-03		GP-WAT-03	

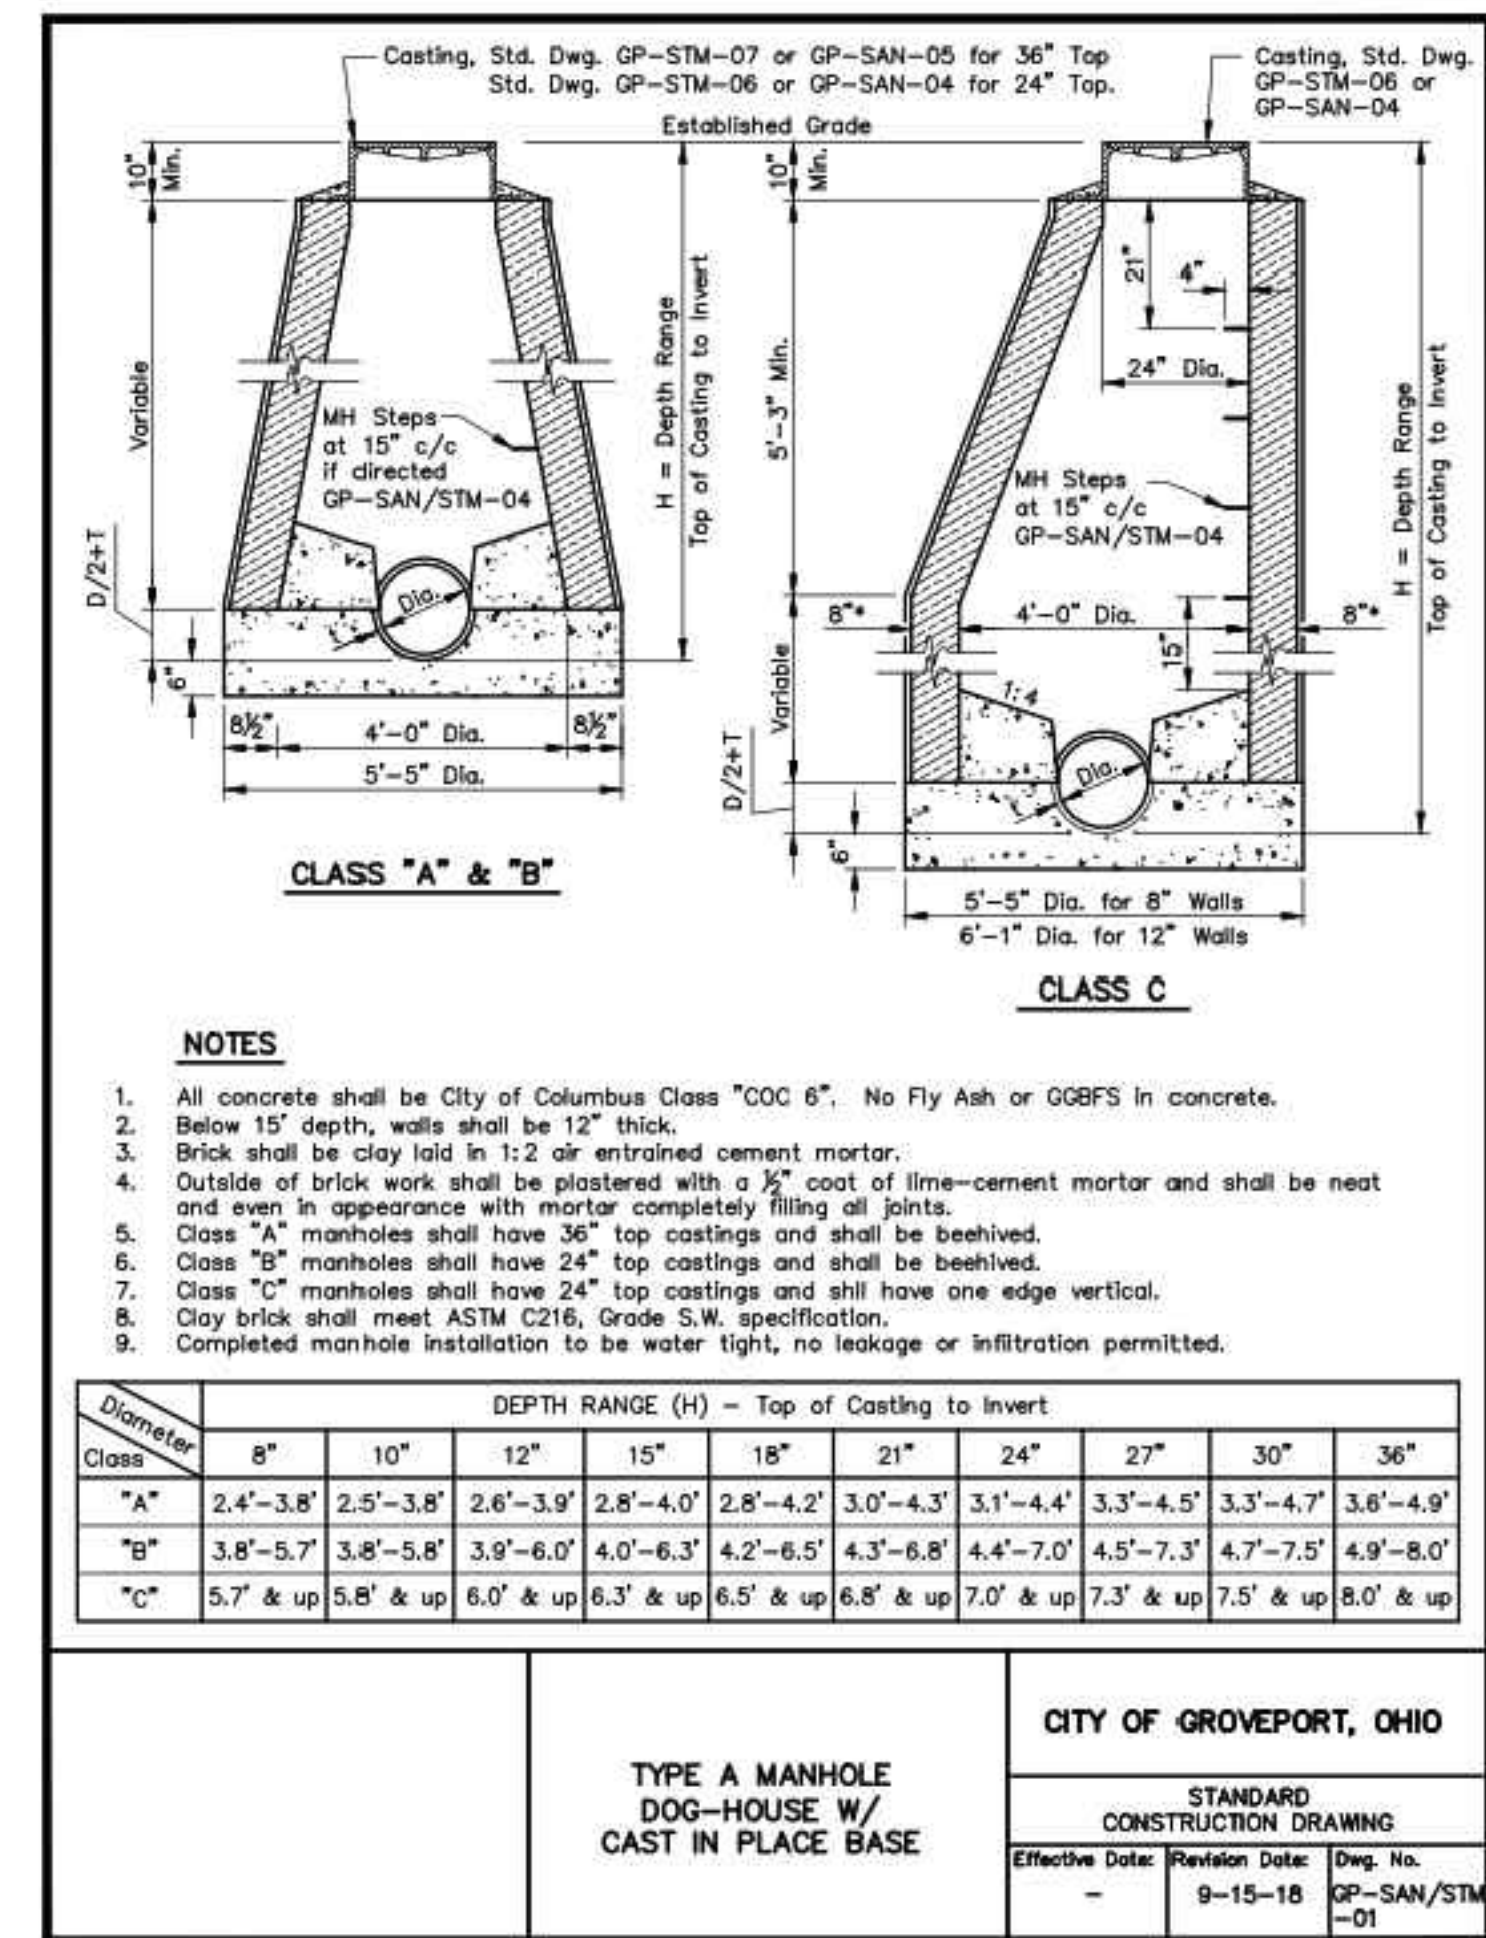


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STANDARD CONSTRUCTION DRAWING		
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-	9-15-18	GP-SAN/STM-01

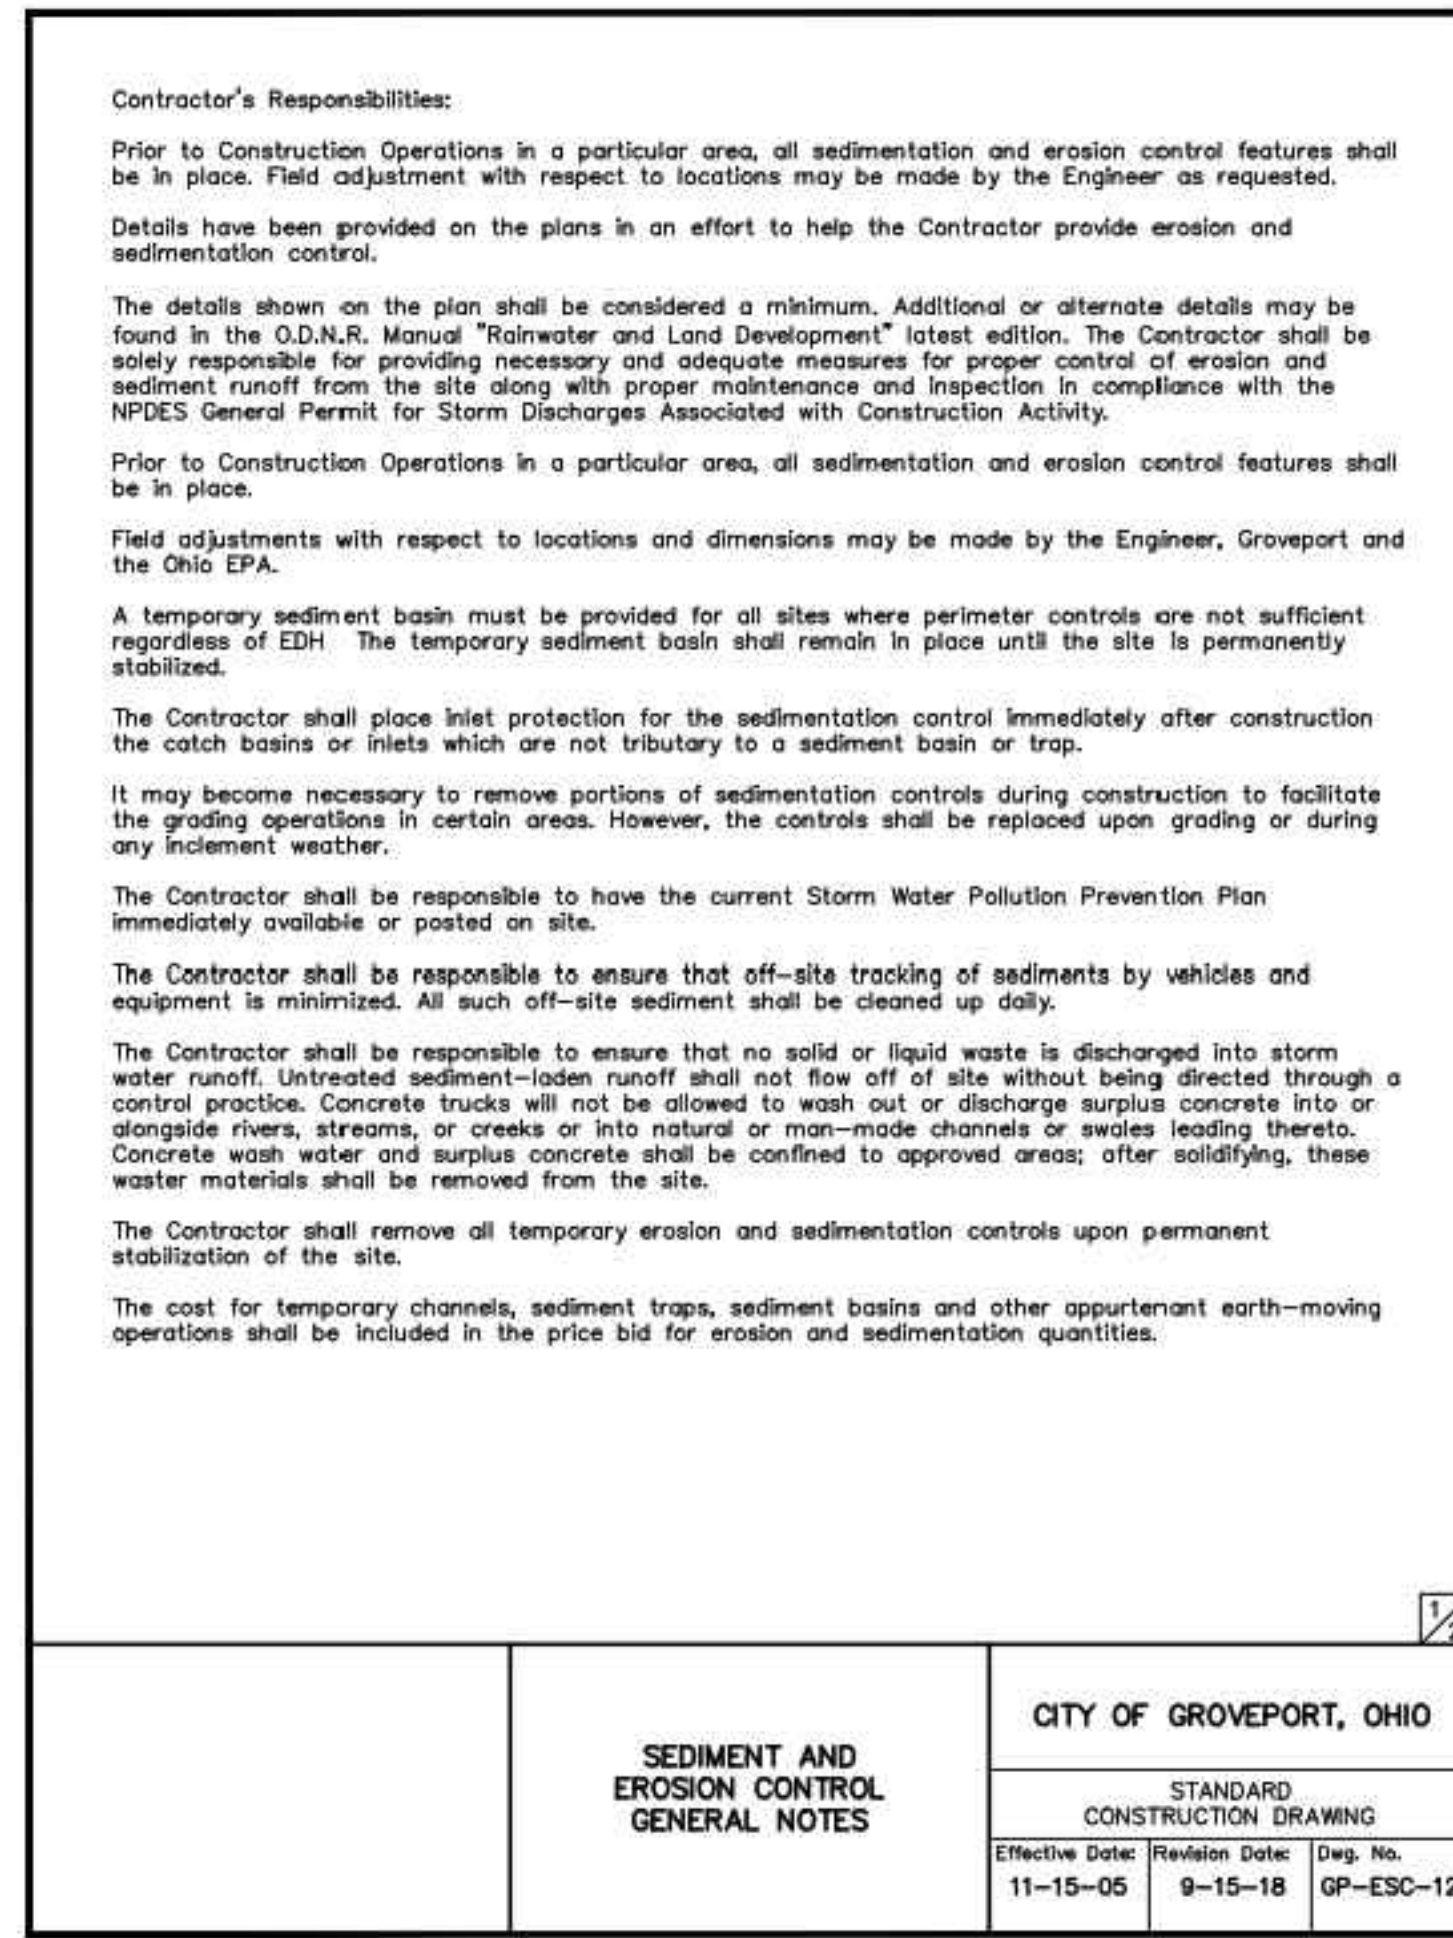

CITY OF GROVEPORT, OHIO		
STANDARD CONSTRUCTION DRAWING		
Effective Date:	Revision Date:	Dwg. No.
11-15-05	9-15-18	GP-ESC-12

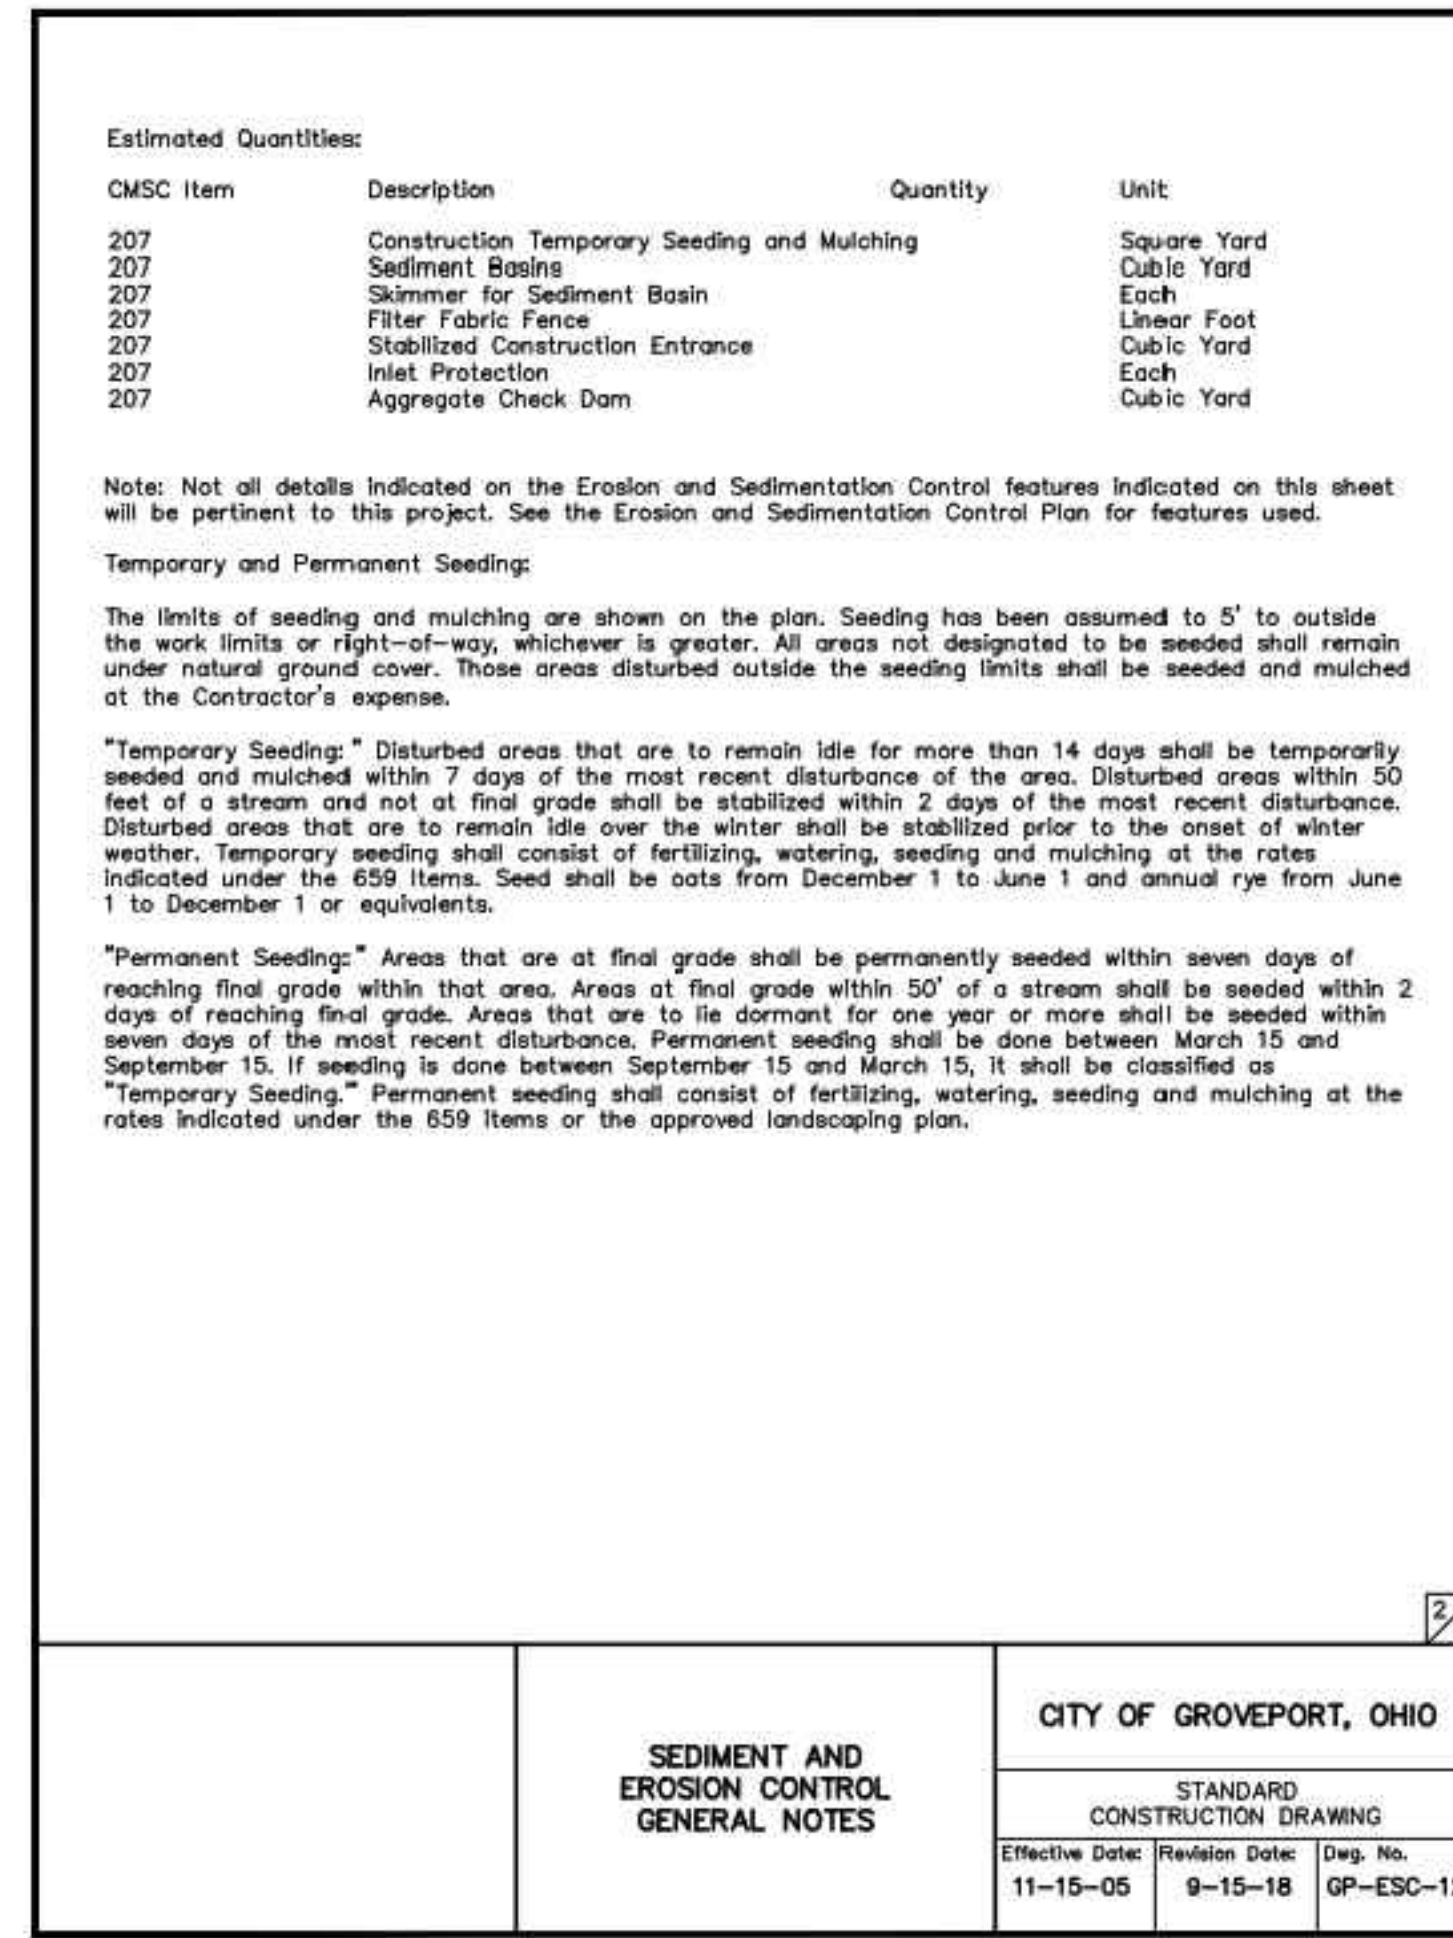

CITY OF GROVEPORT, OHIO		
STANDARD CONSTRUCTION DRAWING		
Effective Date:	Revision Date:	Dwg. No.
11-15-05	9-15-18	GP-ESC-12

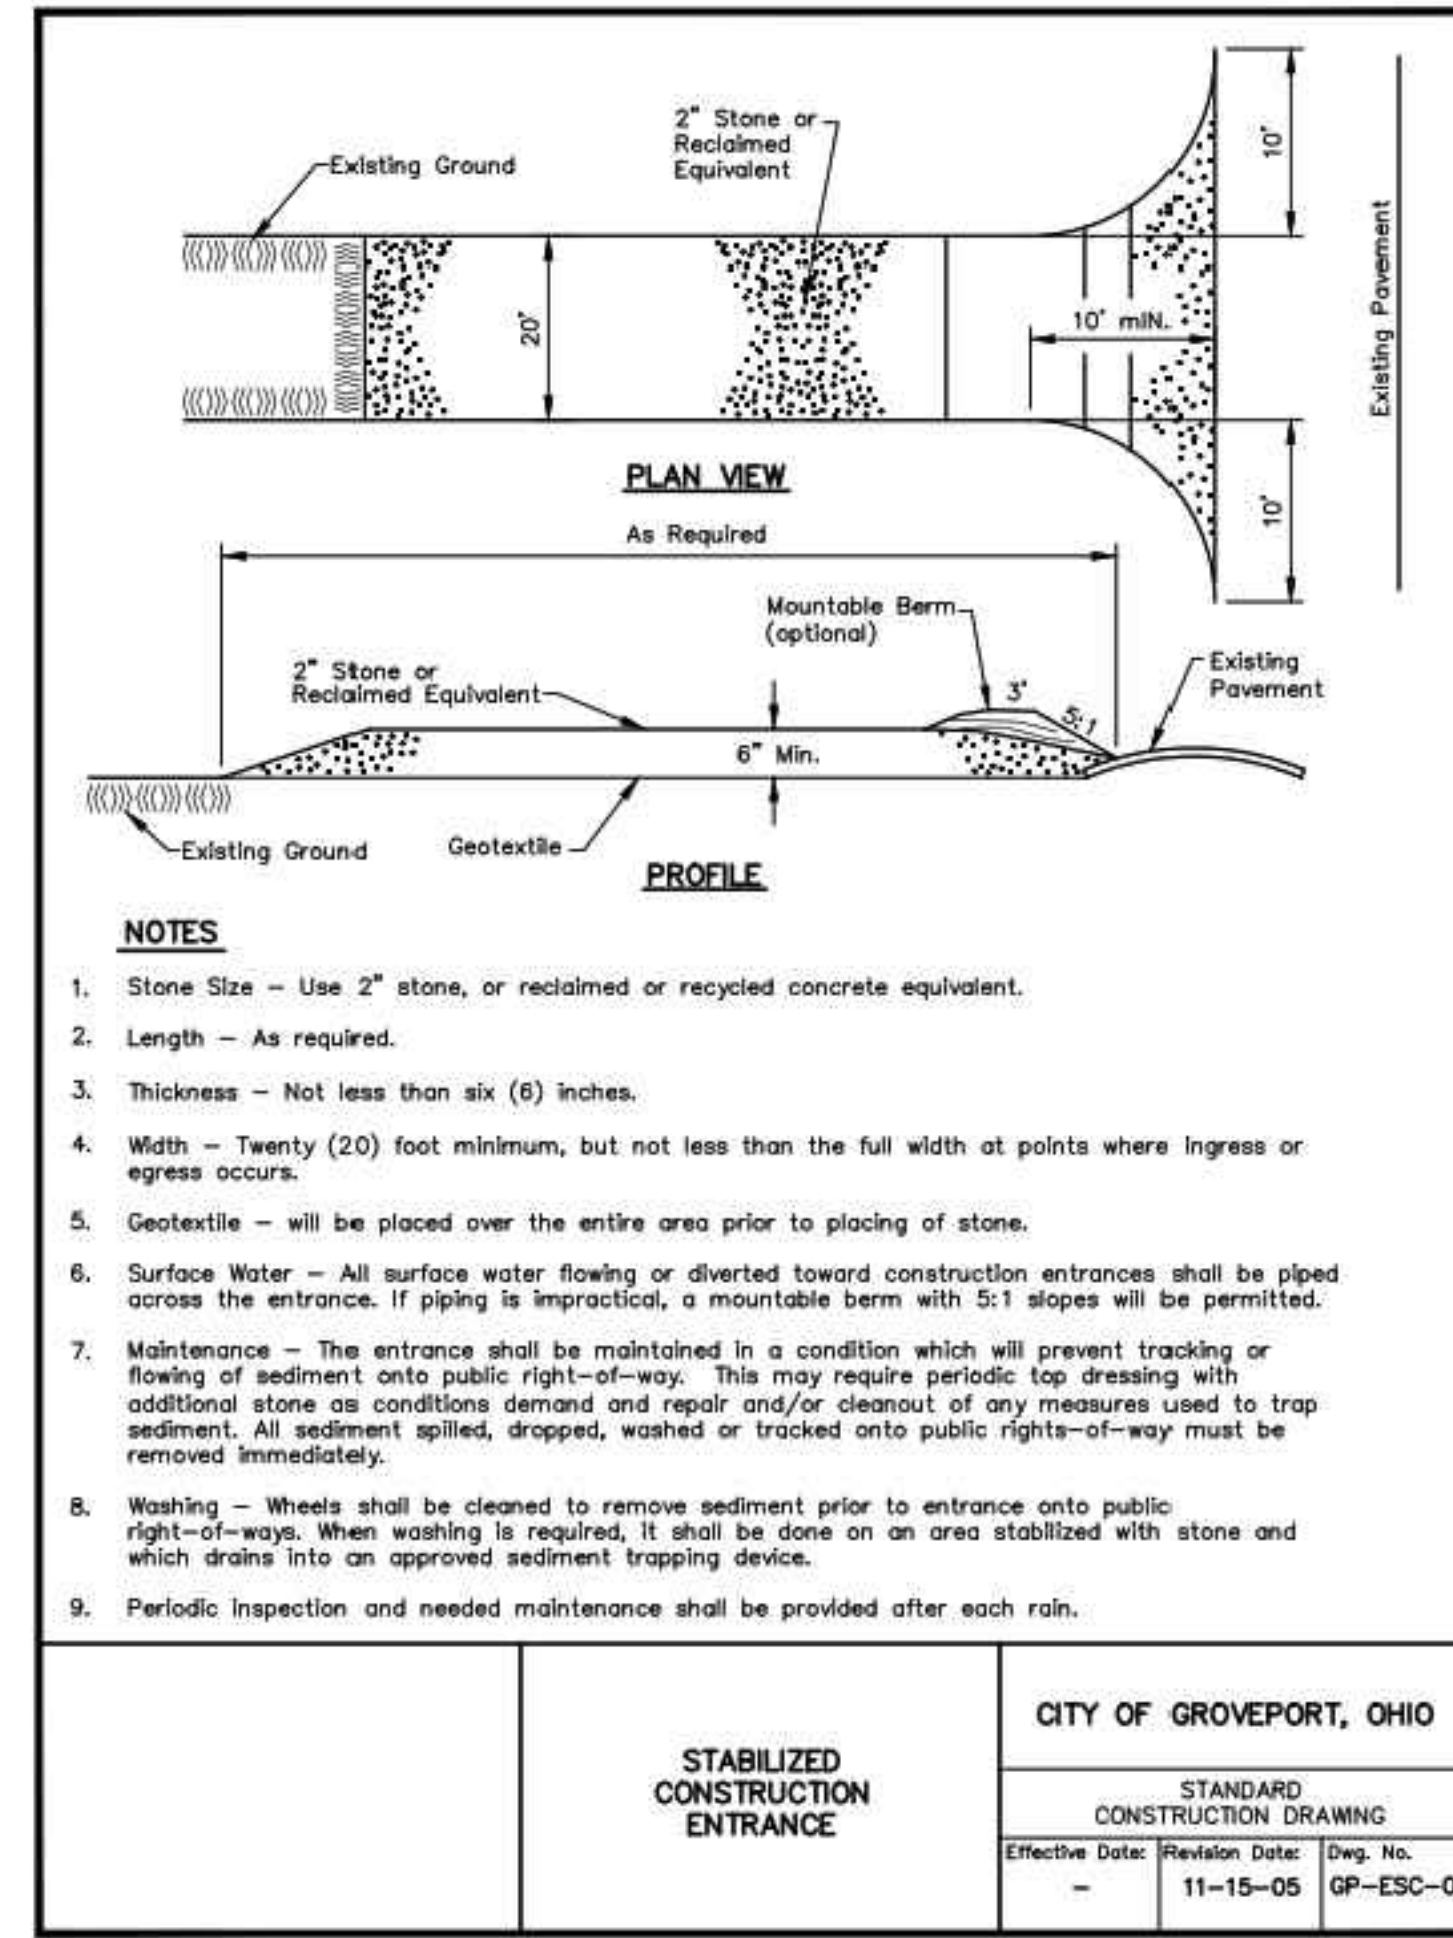

CITY OF GROVEPORT, OHIO		
STANDARD CONSTRUCTION DRAWING		
Effective Date:	Revision Date:	Dwg. No.
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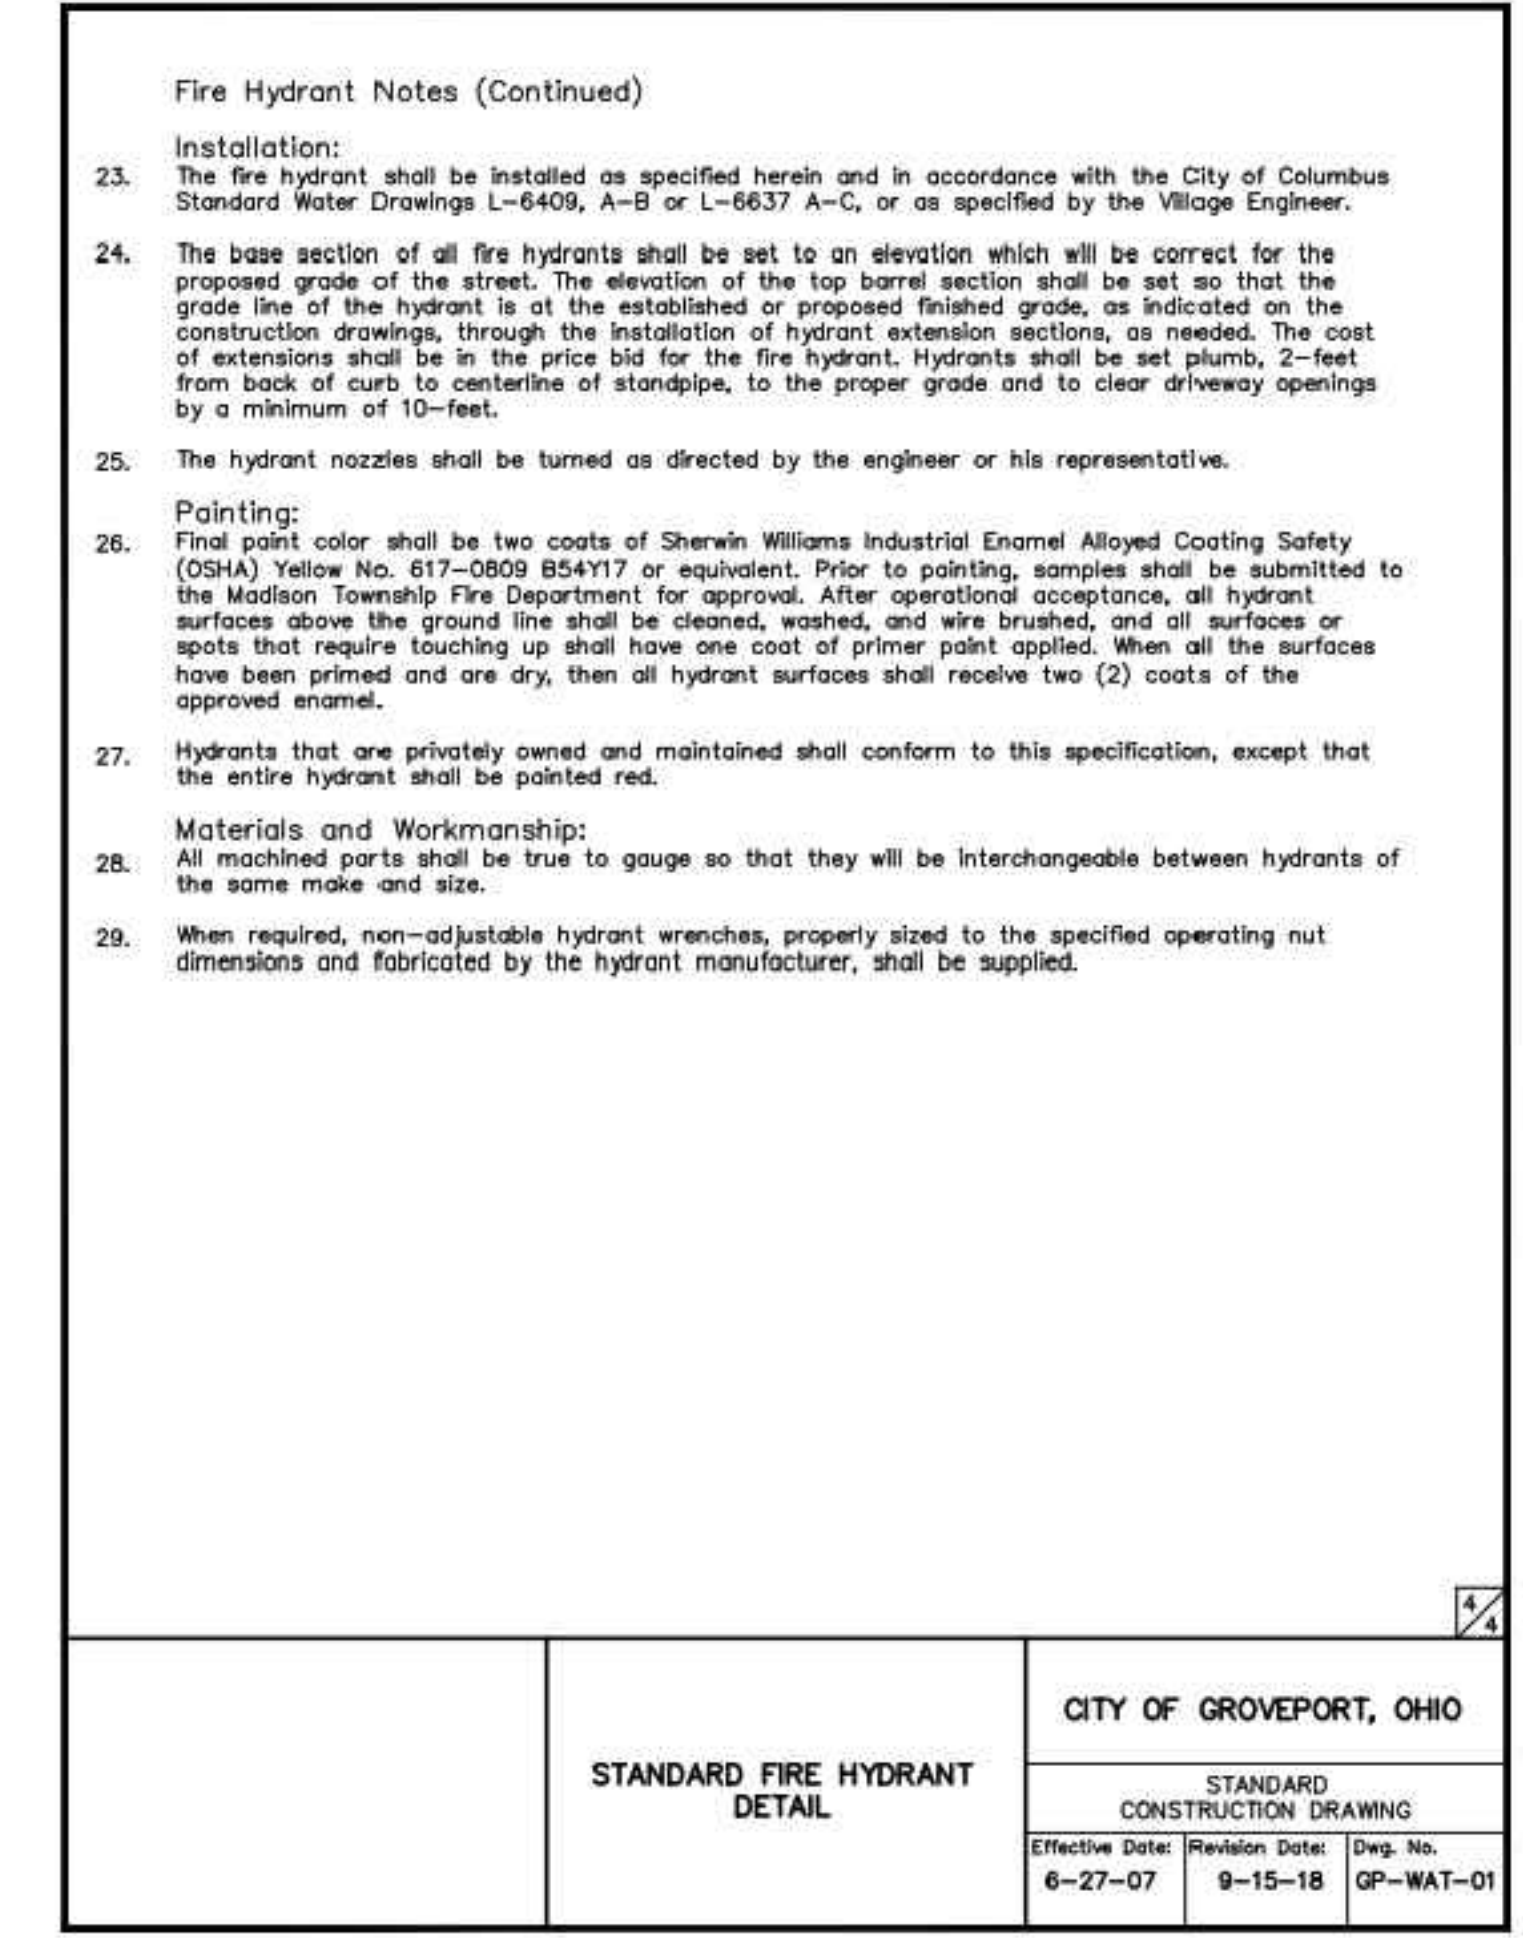
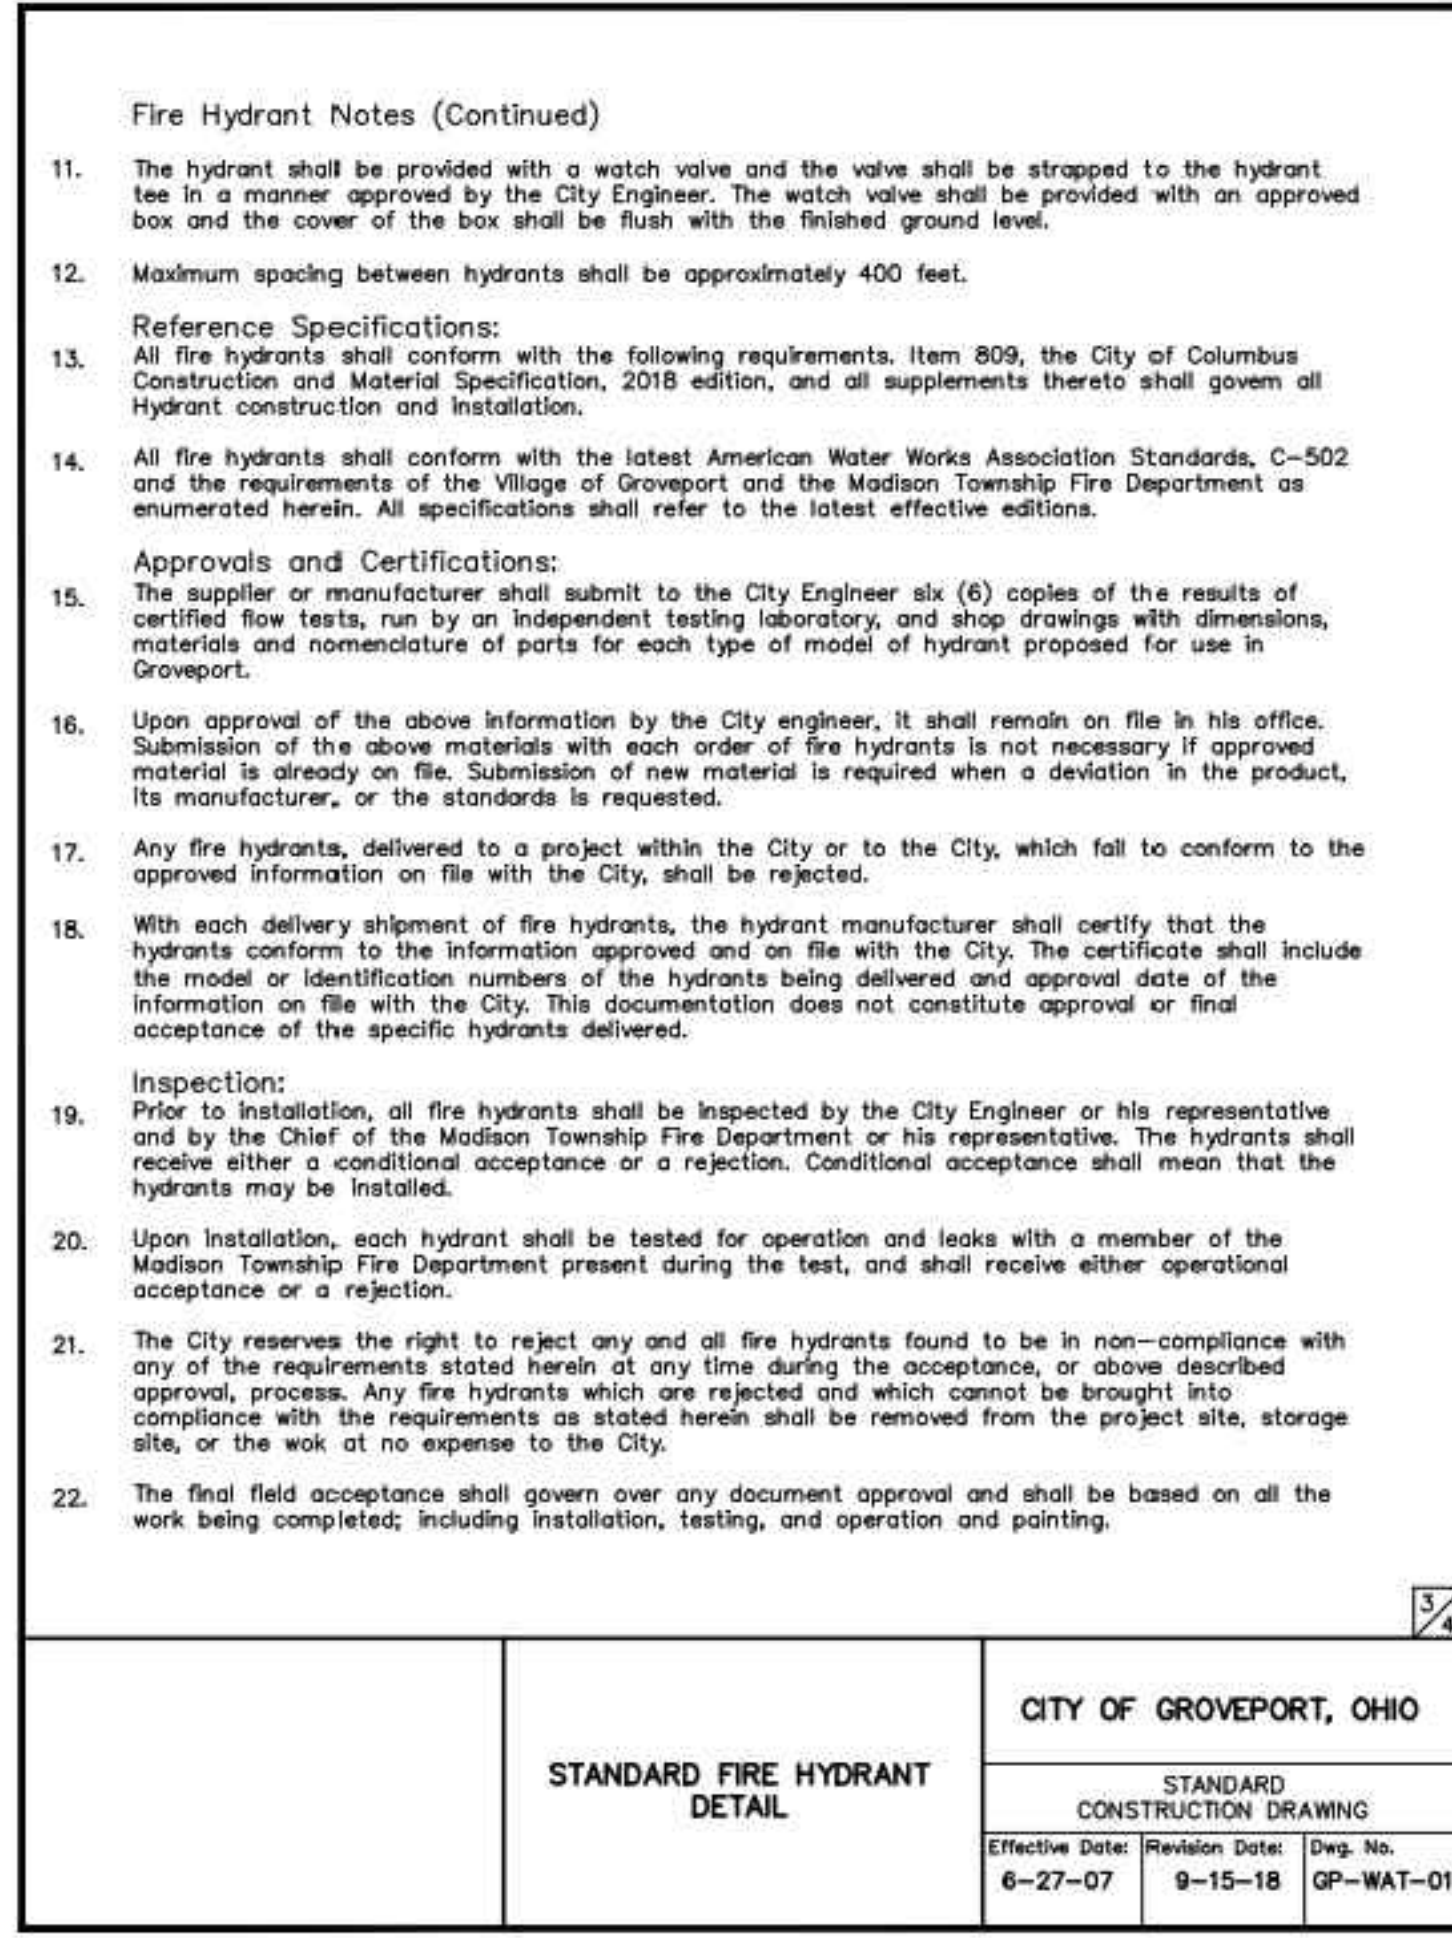
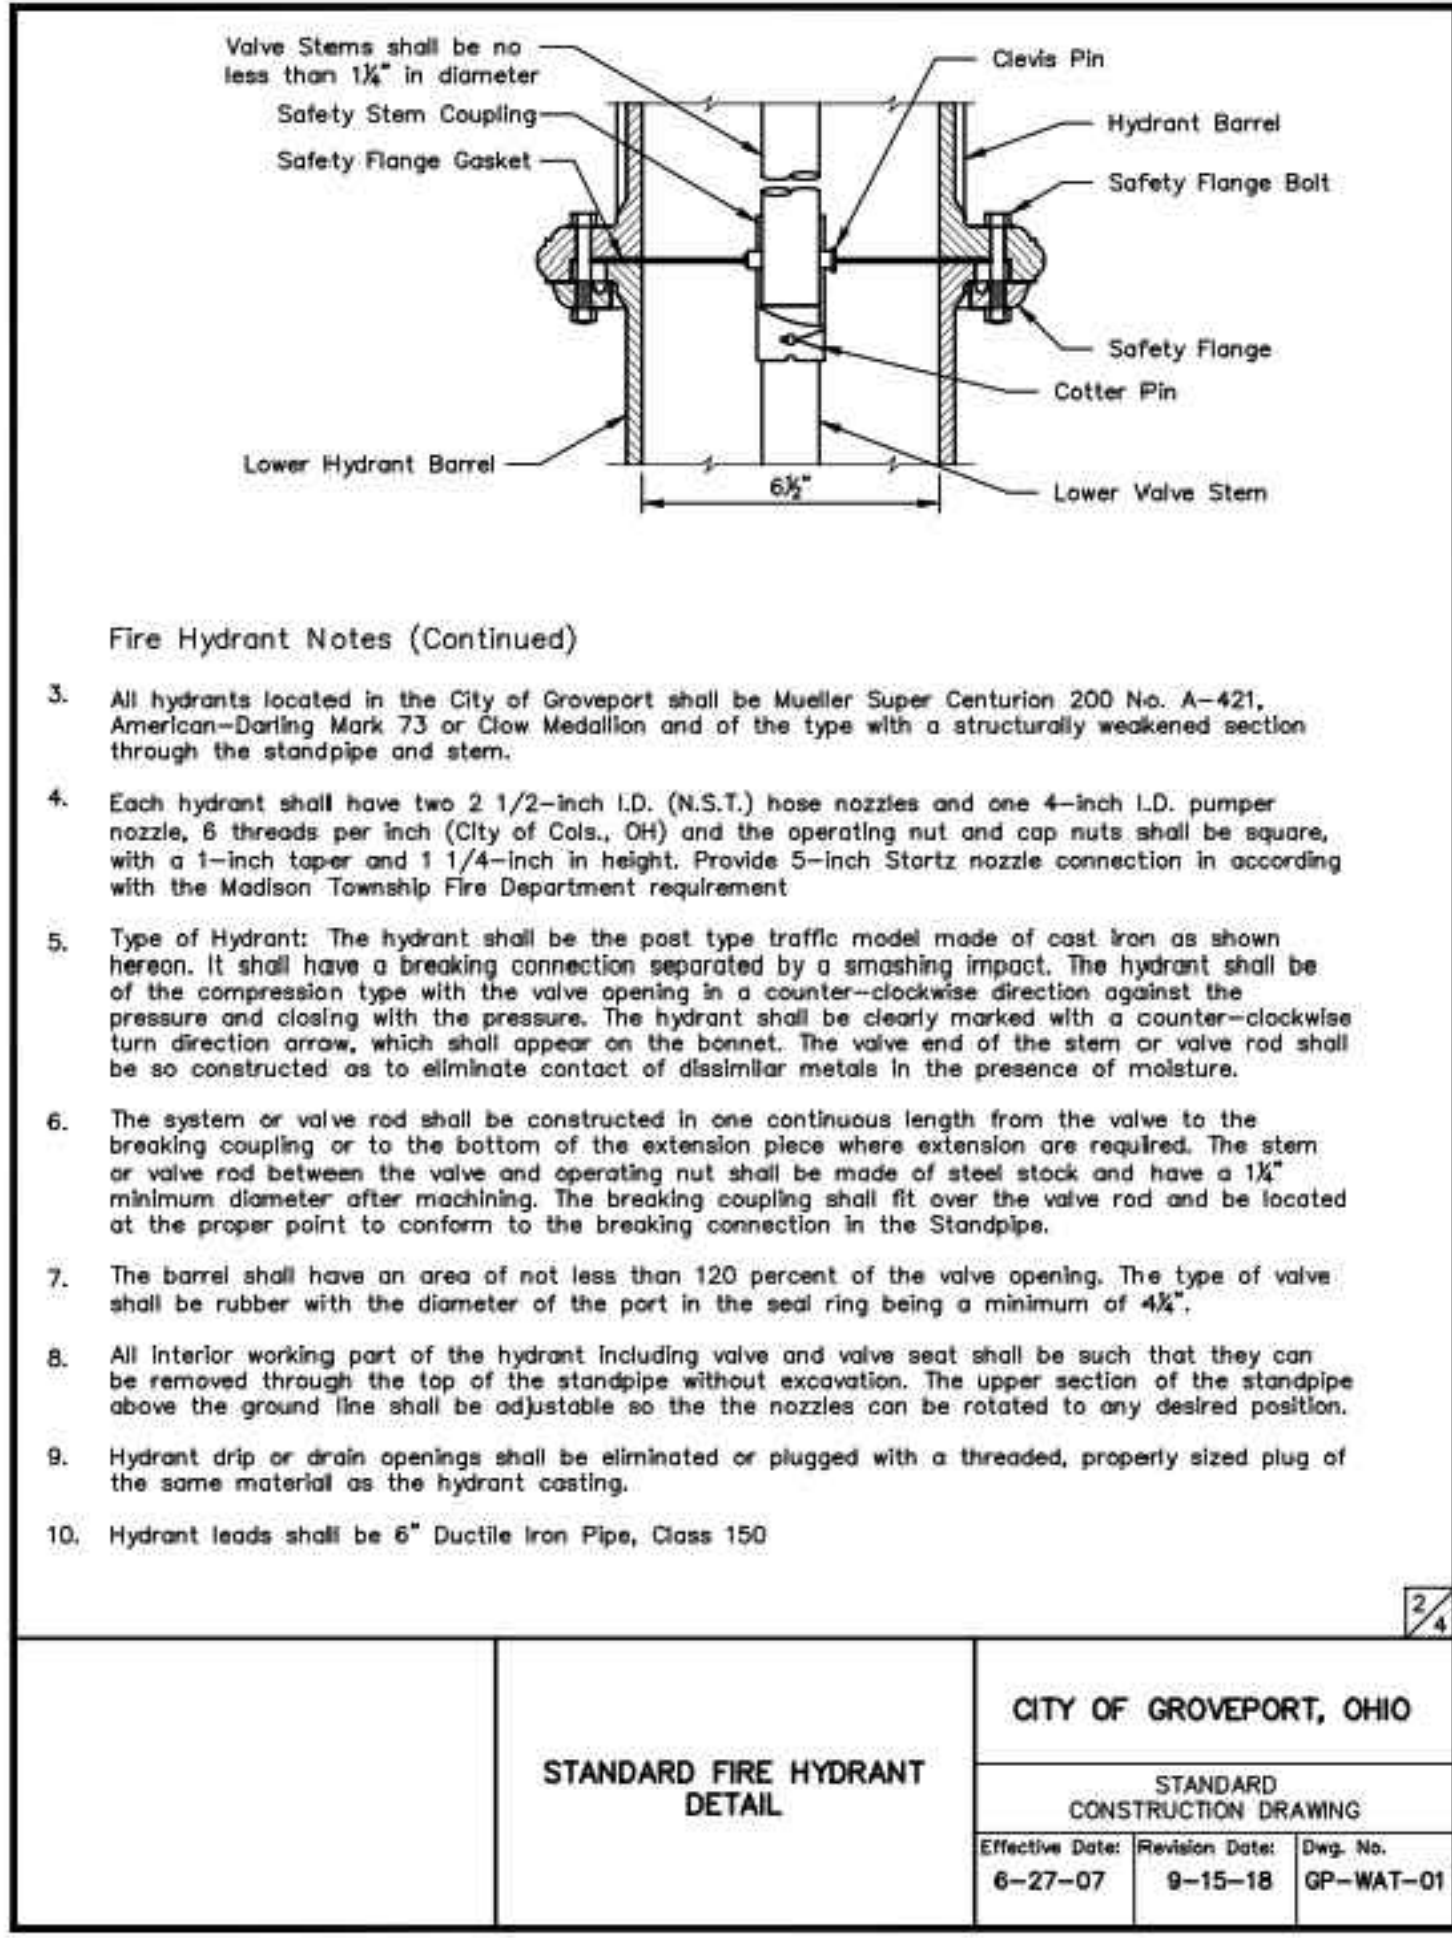
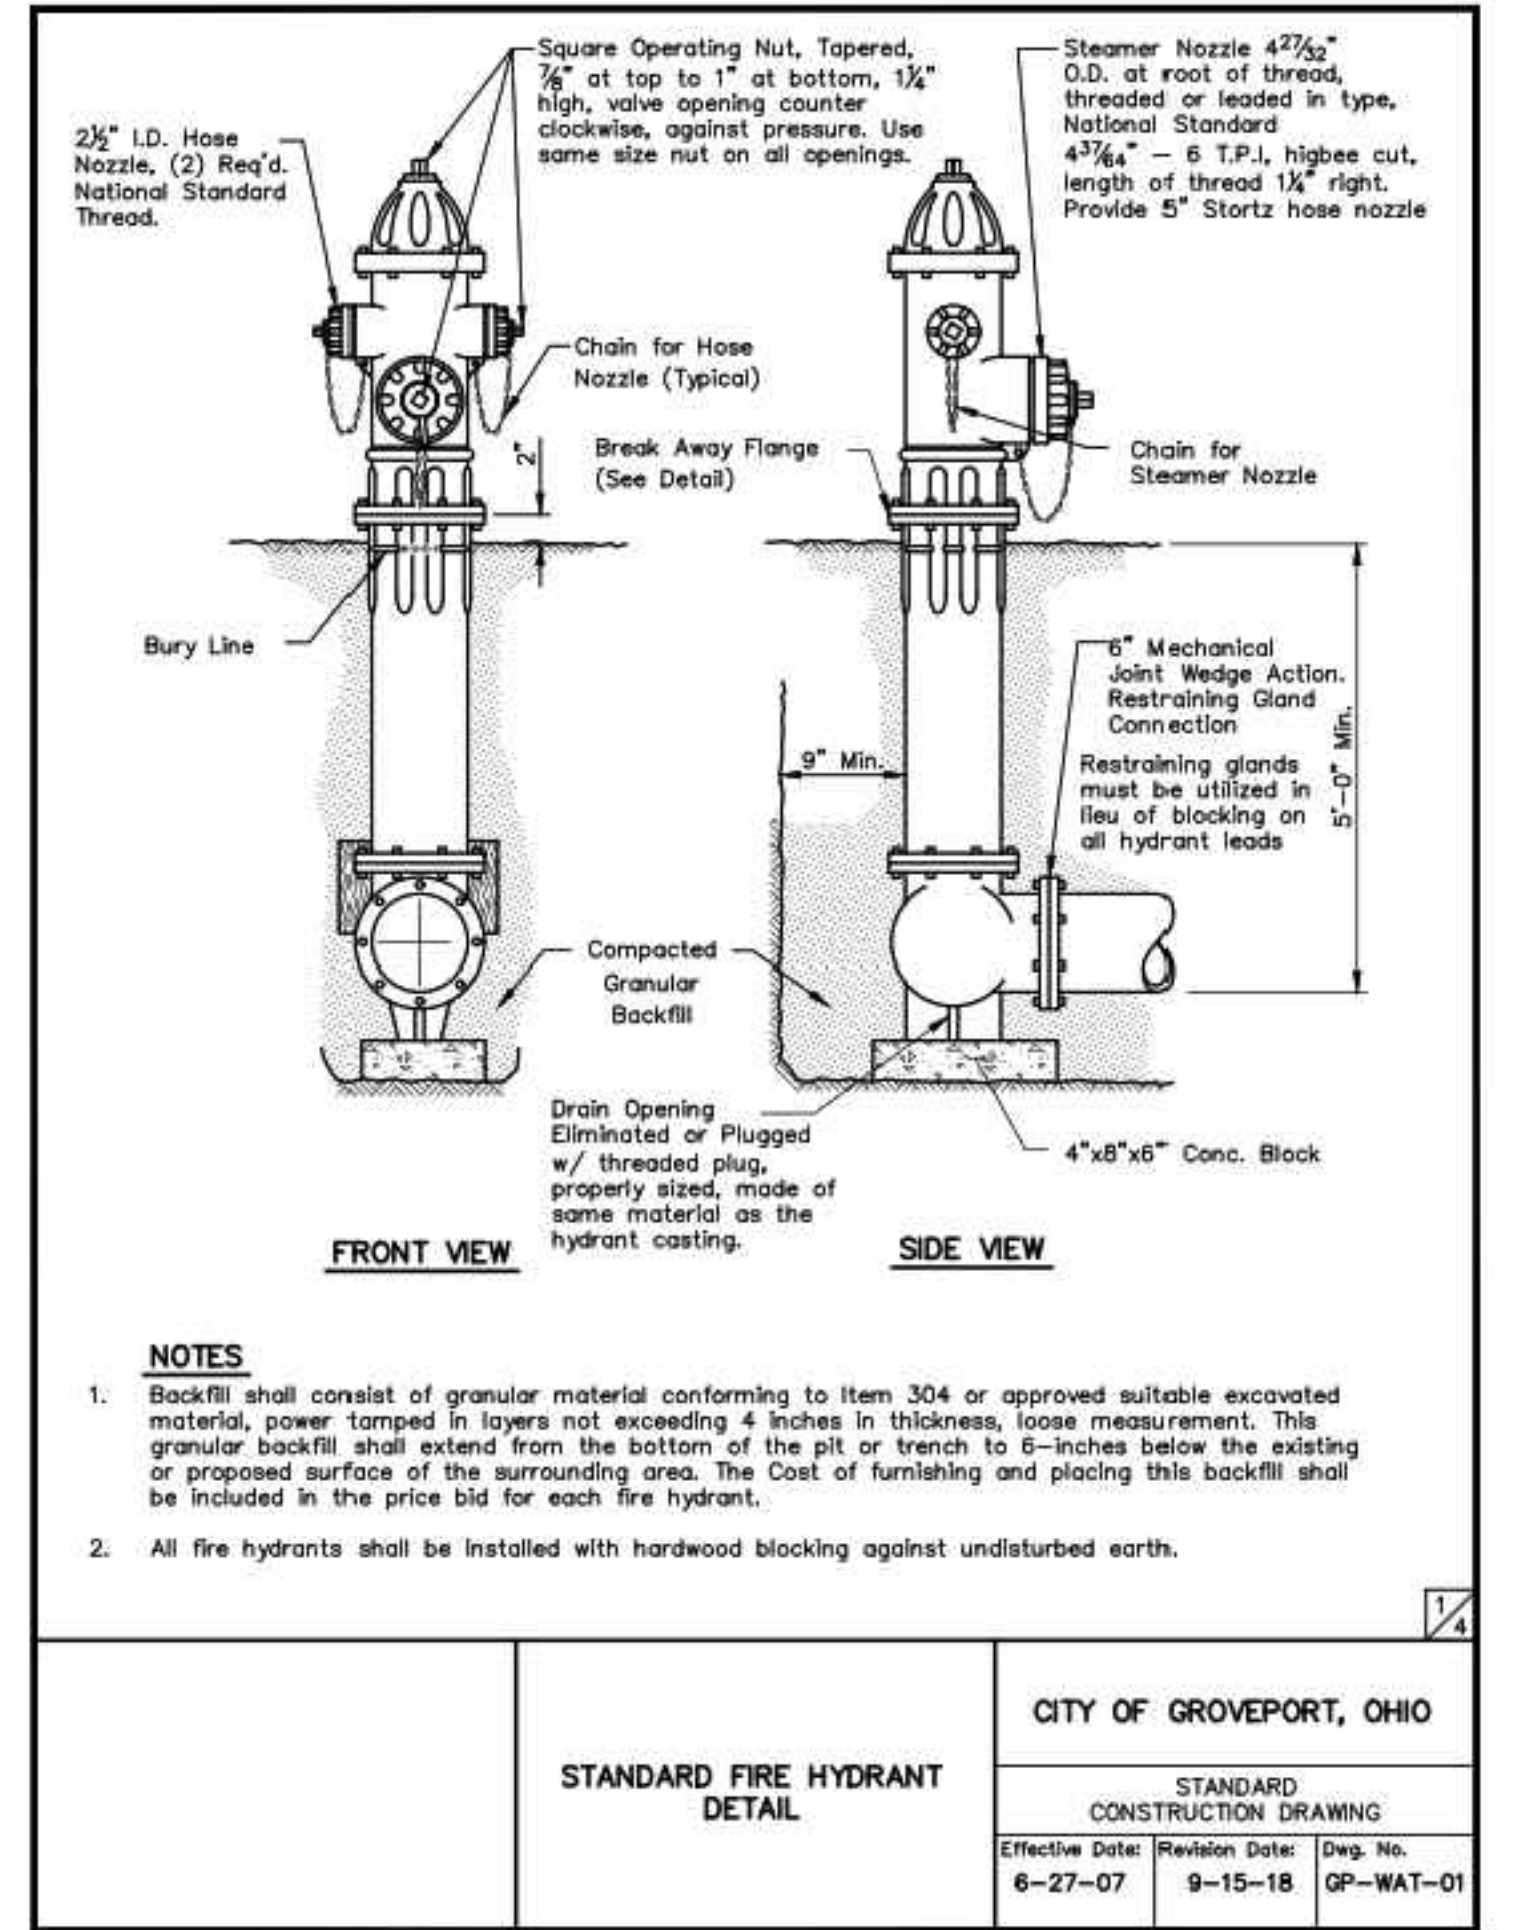
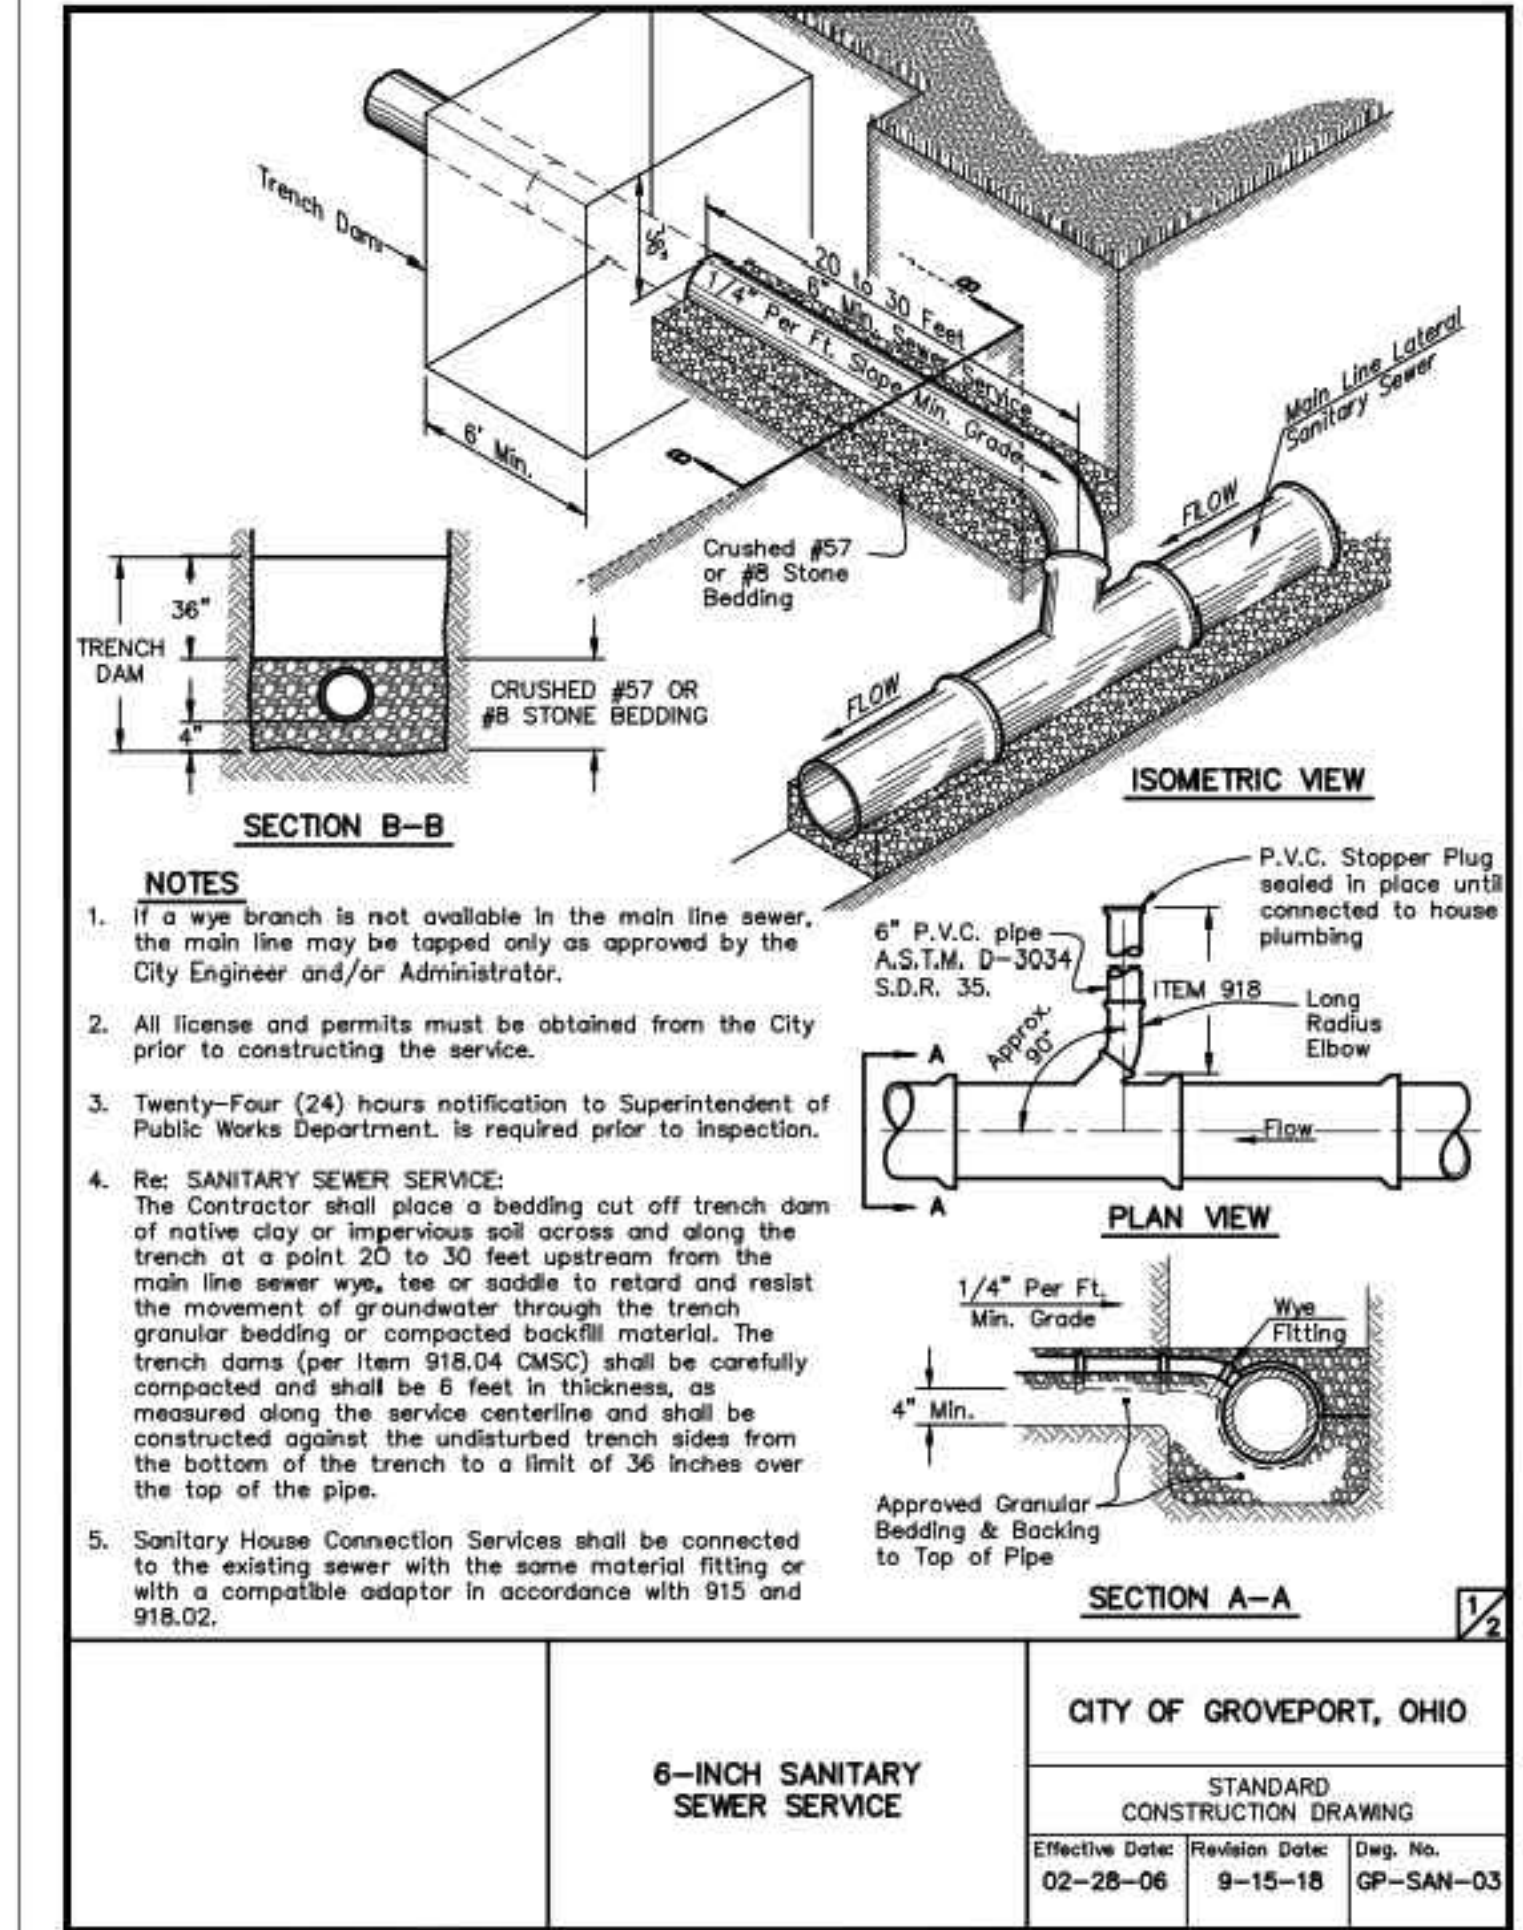
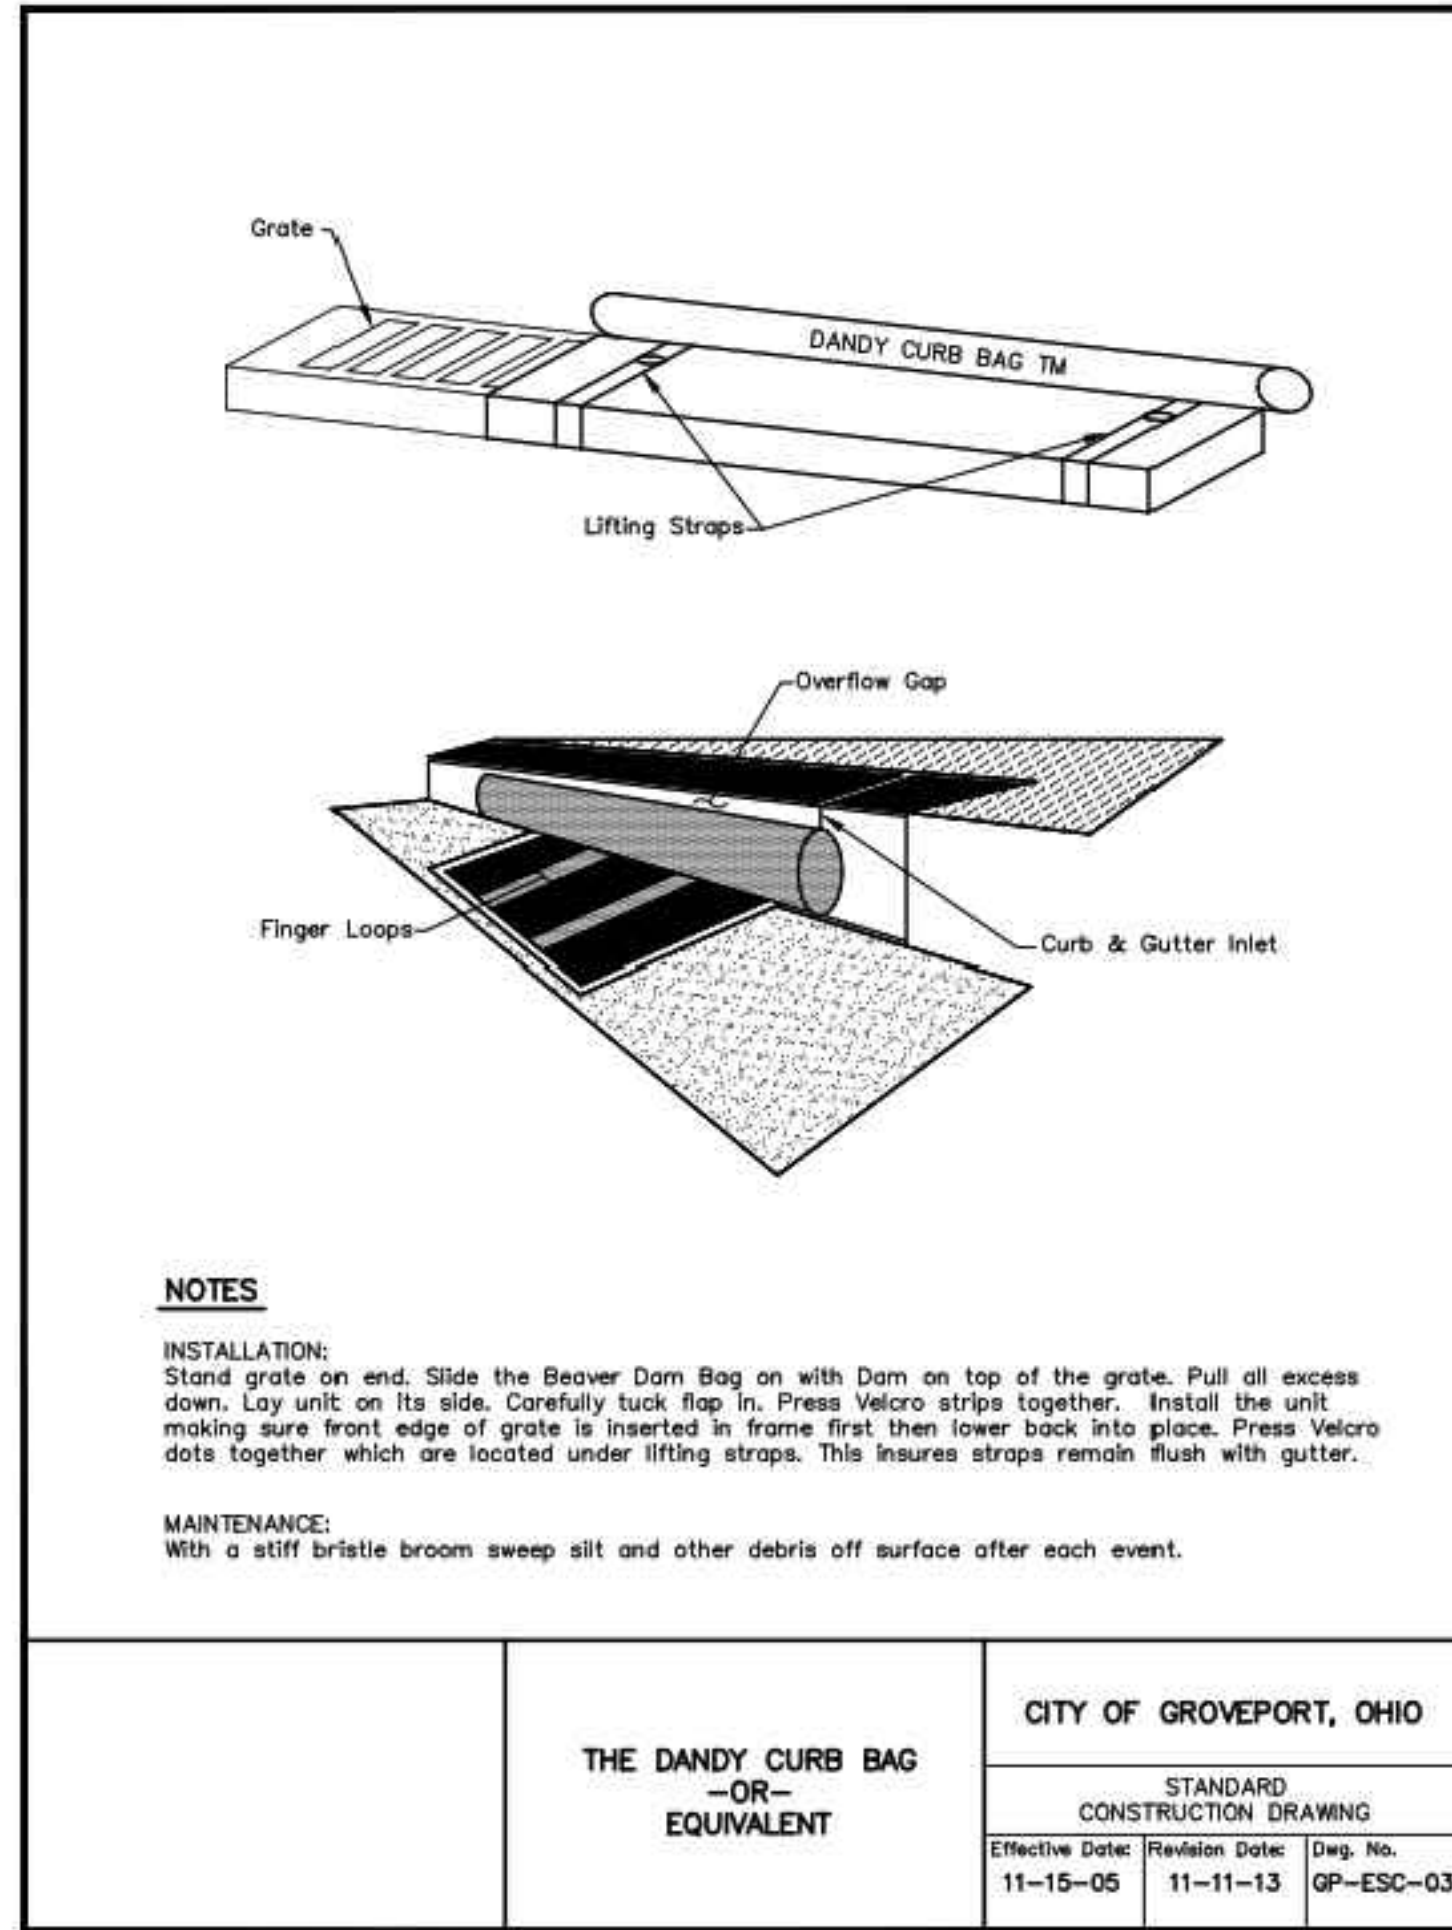
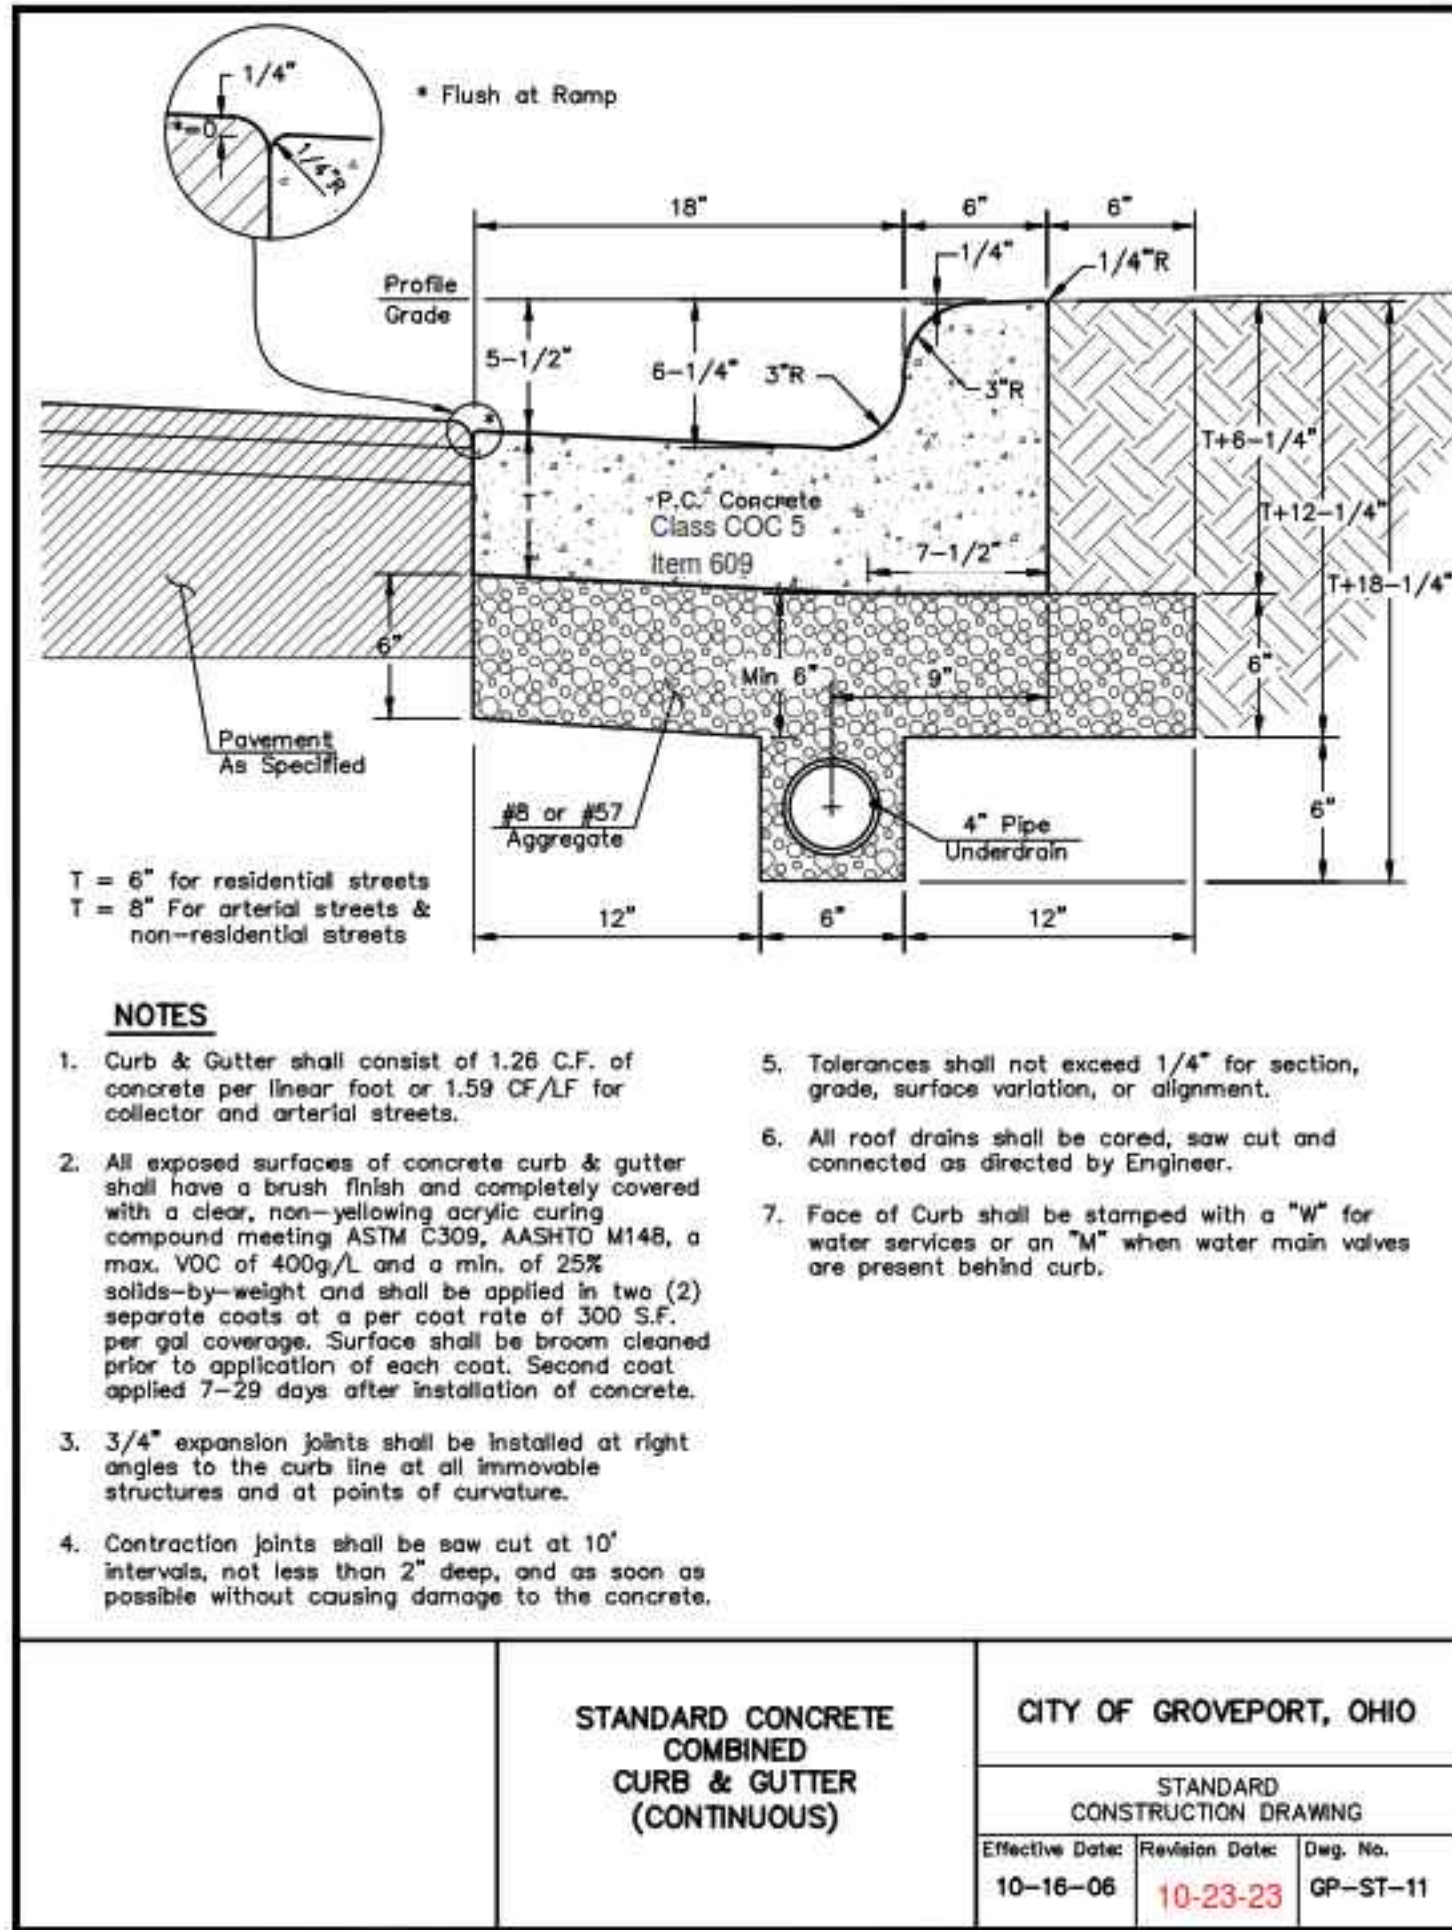
STOIC PROPERTIES
 NEWPORT VILLAGE SECTION 5
 SECTION 28, TOWNSHIP 11, RANGE 21
 CITY OF GROVEPORT
 FRANKLIN COUNTY, OH
 CONTAINING - 2.1489 TOTAL ACRES
 JULY 2024

SURVEYOR
 J. BRYANT ABT, PS
 OHIO P.S. # 8593
 BA LAND PROFESSIONALS, LLC
 301 BOURBON ST
 BLANCHESTER, OH 45107
 937.558.6671
 HTTPS://BALANDPROS.COM
 ABT@BALANDPROS.COM

CITY OF GROVEPORT - STANDARD DWGS	
NEWPORT VILLAGE SECTION 5	
CROW AVE CITY OF GROVEPORT	SECTION 28, TOWNSHIP 11, RANGE 21 FRANKLIN COUNTY, OHIO
SCALE: 1" = 20'	DATE: 06/10/2024 REV 07/15/2024

DESIGN:	N/A	JOB NO.:	24-0106
DRAWN:	N/A	SHEET NO.:	7 OF 9
CHECKED:	JBA		







STOIC PROPERTIES
 NEWPORT VILLAGE SECTION 5
 SECTION 28, TOWNSHIP 11, RANGE 21
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SCALE: 1" = 20'	DATE: 06/10/2024 REV 07/15/2024
DESIGN: N/A	JOB NO.: 24-0106
DRAWN: N/A	SHEET NO.:
CHECKED: JBA	BA LAND PROFESSIONALS
	8 OF 9




STOIC PROPERTIES
 NEWPORT VILLAGE SECTION 5
 SECTION 28, TOWNSHIP 11, RANGE 21
 CITY OF GROVEPORT
 FRANKLIN COUNTY, OH
 CONTAINING - 2.1489 TOTAL ACRES
 JULY 2024

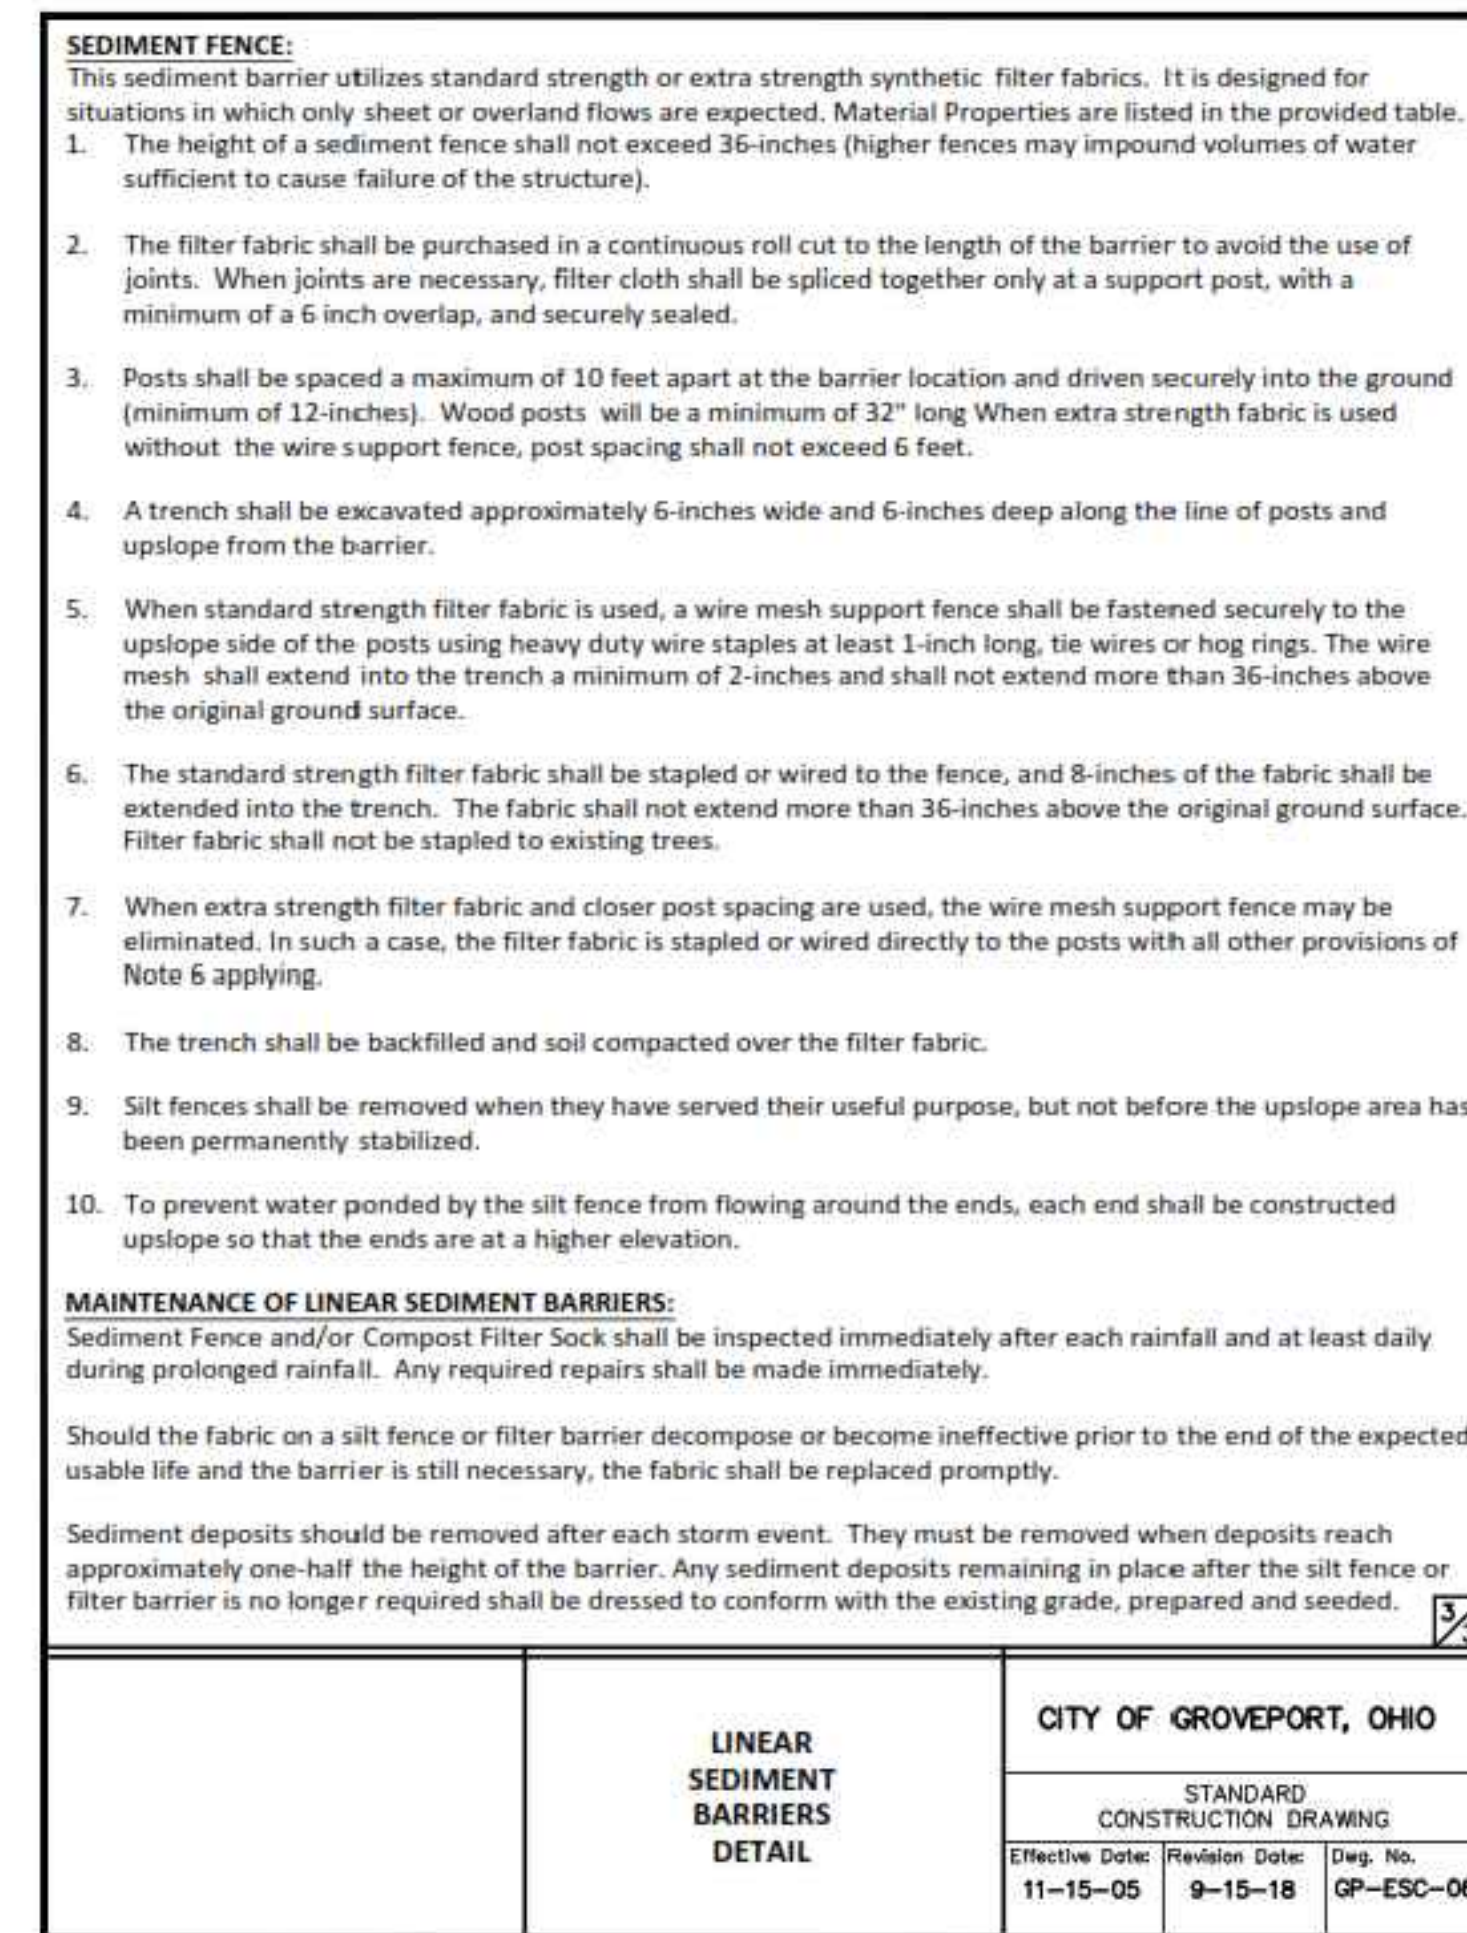
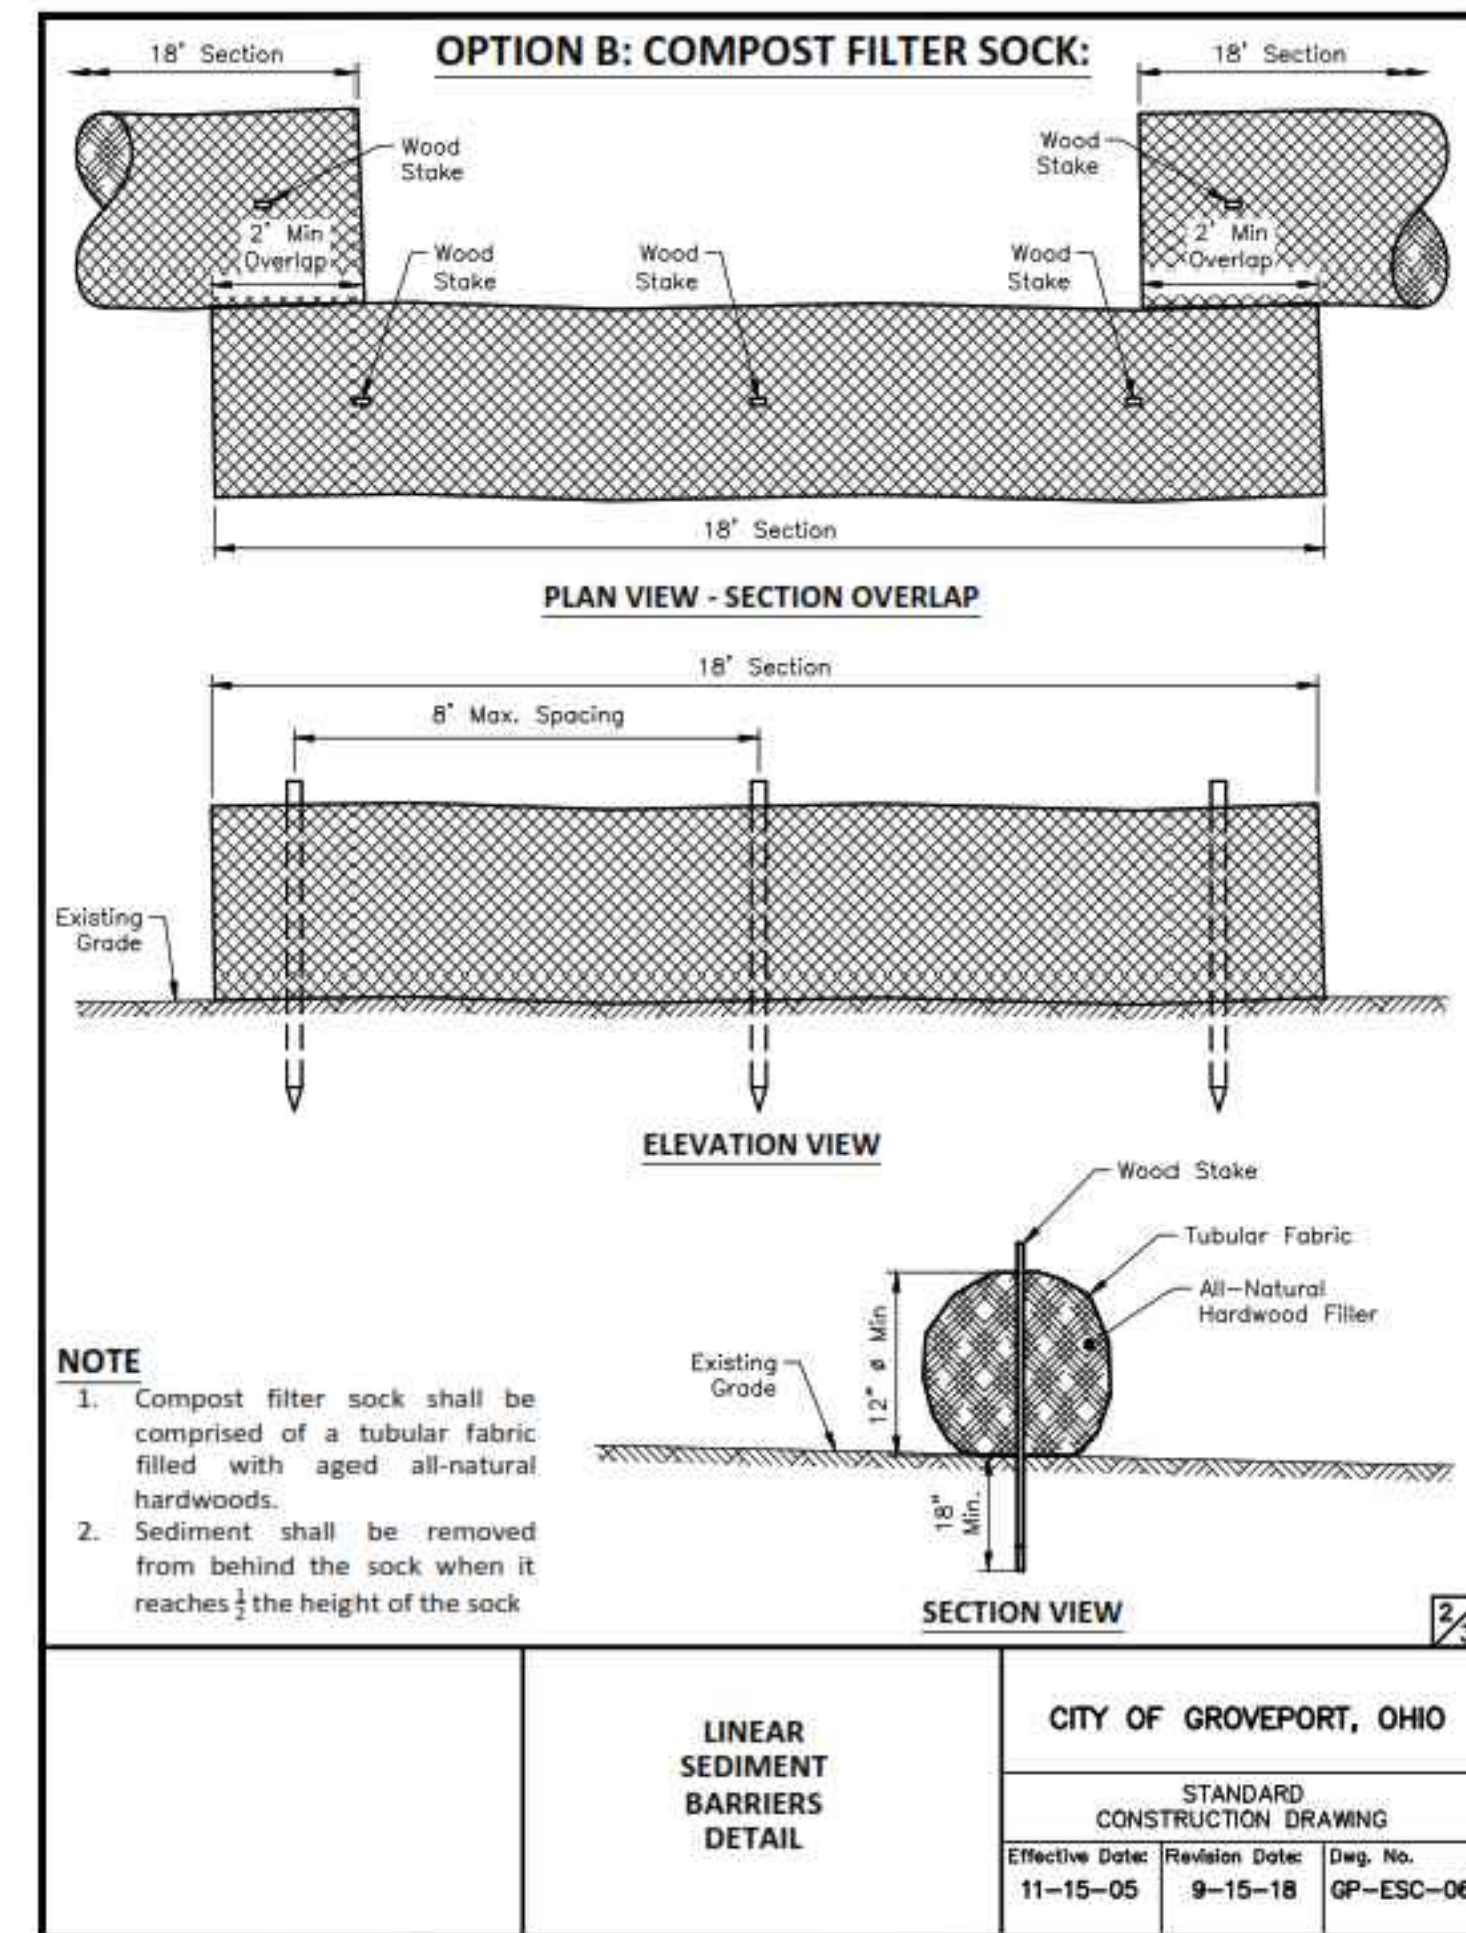
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CITY OF GROVEPORT - STANDARD DWGS	
NEWPORT VILLAGE SECTION 5	
CROW AVE CITY OF GROVEPORT	SECTION 28, TOWNSHIP 11, RANGE 21 FRANKLIN COUNTY, OHIO
SCALE: 1" = 20'	DATE: 06/10/2024 REV 07/15/2024
DESIGN: N/A	JOB NO.: 24-0106
DRAWN: N/A	SHEET NO.:
CHECKED: JBA	9 OF 9



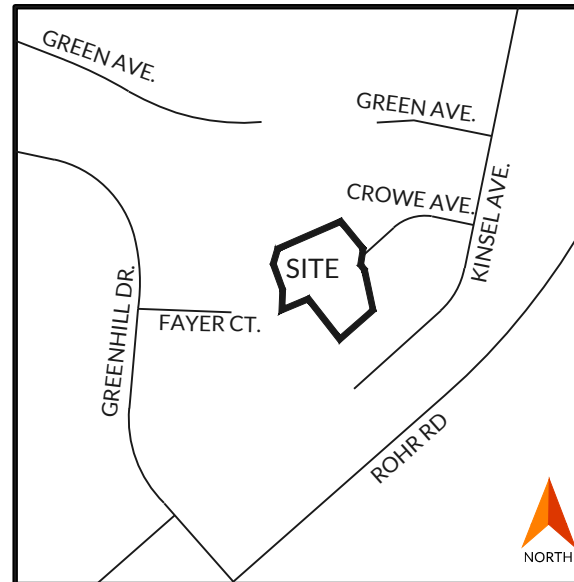

VICINITY MAP
NOT TO SCALE

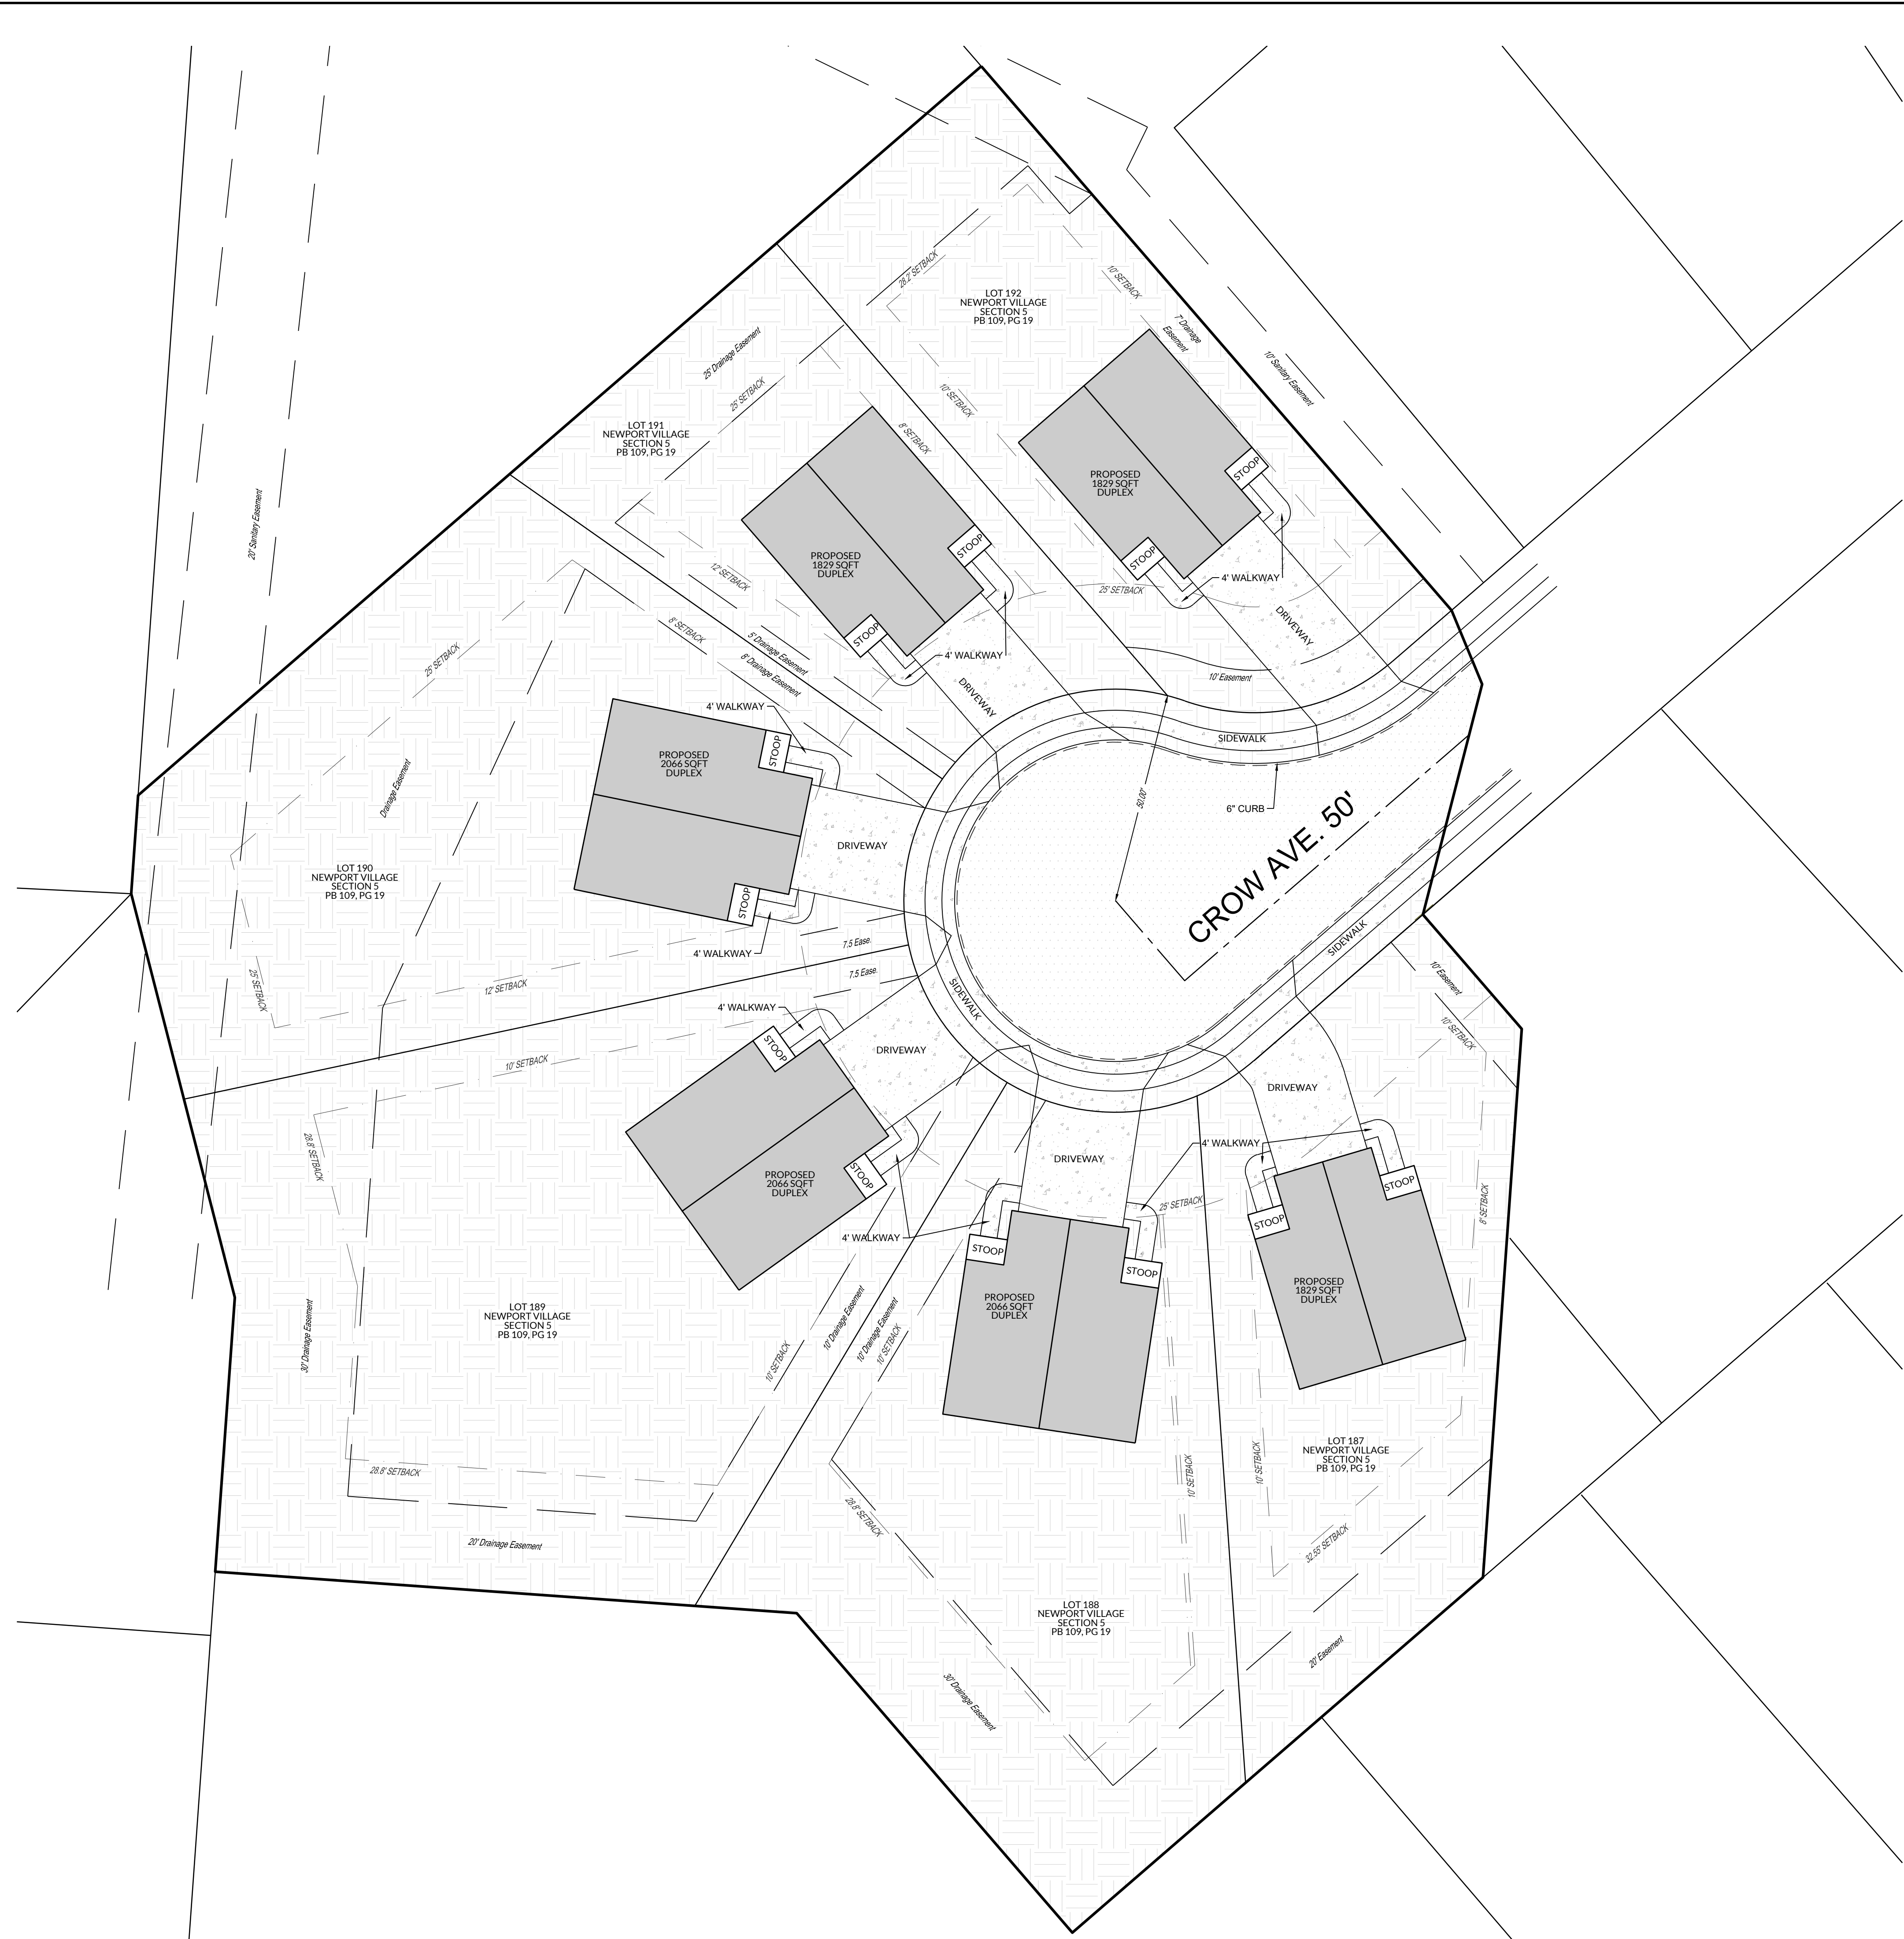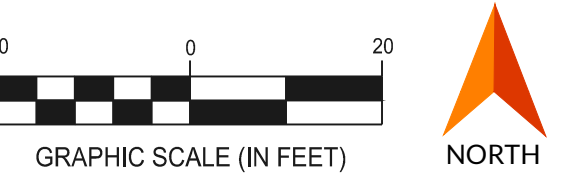

FLOOD ZONE NOTE:

THIS PROPERTY CURRENTLY LIES IN ZONE "X" AREA OF MINIMAL FLOOD HAZARD AS SHOWN ON THE FEMA FIRM (FLOOD INSURANCE RATE MAP) NUMBER 39049C0432K WITH AN EFFECTIVE DATE OF JUNE 17, 2008. THIS FLOOD ZONE DETERMINATION IS MADE BY VISUAL INSPECTION OF THE CURRENT FIRM AND IS NOT AN ACTUAL FEMA ELEVATION CERTIFICATE.

VESTING DEED INFORMATION

LOTS 187-192 OF THE SUBDIVISION OF NEWPORT VILLAGE SECTION 5 AS RECORDED IN PB 109, PAGE 19 AND OF THE LANDS OF TOP GUN INVESTMENTS, LLC AS RECORDED IN INSTRUMENT # 202306140058725 OF THE FRANKLIN COUNTY DEED RECORDS, ON FILE IN COLUMBUS, OH


MAP LEGEND

- BOUNDARY LINE
- LOT LINE
- EASEMENT LINE
- SETBACK LINE
- ROADWAY CENTERLINE
- BUILDING LINE
- PROPOSED CONCRETE
- PROPOSED ASPHALT
- PROPOSED LAWN


SITE NOTES:

1. THIS EXHIBIT IS FOR INFORMATIONAL PURPOSES ONLY AND IS A CONCEPTUAL DRAWING SHOWING THE PROPOSED LAYOUT OF BUILDINGS. THIS IS NOT A SURVEY PURSUANT OAC 4733-37
2. FOR CONCEPTUAL USE ONLY, NOT FOR CONSTRUCTION.
3. SUBJECT TO APPROVAL OF A GENERAL USE CHANGE, ALLOWING MULTI FAMILY (DUPLX HOUSING) ON LOTS 188-190
4. INFORMATION SHOWN BASED UPON THE RECORD PLAT OF NEWPORT VILLAGE, SECTION 5 AS RECORDED IN PB 109, PAGE 19 OF THE FRANKLIN COUNTY DEED AND PLAT RECORDS, ON FILE IN COLUMBUS OHIO.


SITE CONCEPTUAL PLAN	
NEWPORT VILLAGE SECTION 5	
CROW AVE CITY OF GROVEPORT	
SECTION 28, TOWNSHIP 11, RANGE 21 FRANKLIN COUNTY, OHIO	
SCALE: 1" = 20'	DATE: 1/31/24 REV 03/15/24
DESIGN: JBA	JOB NO.: 24-0106
DRAWN: JBA	SHEET NO.:
CHECKED: DPB	 1 OF 1

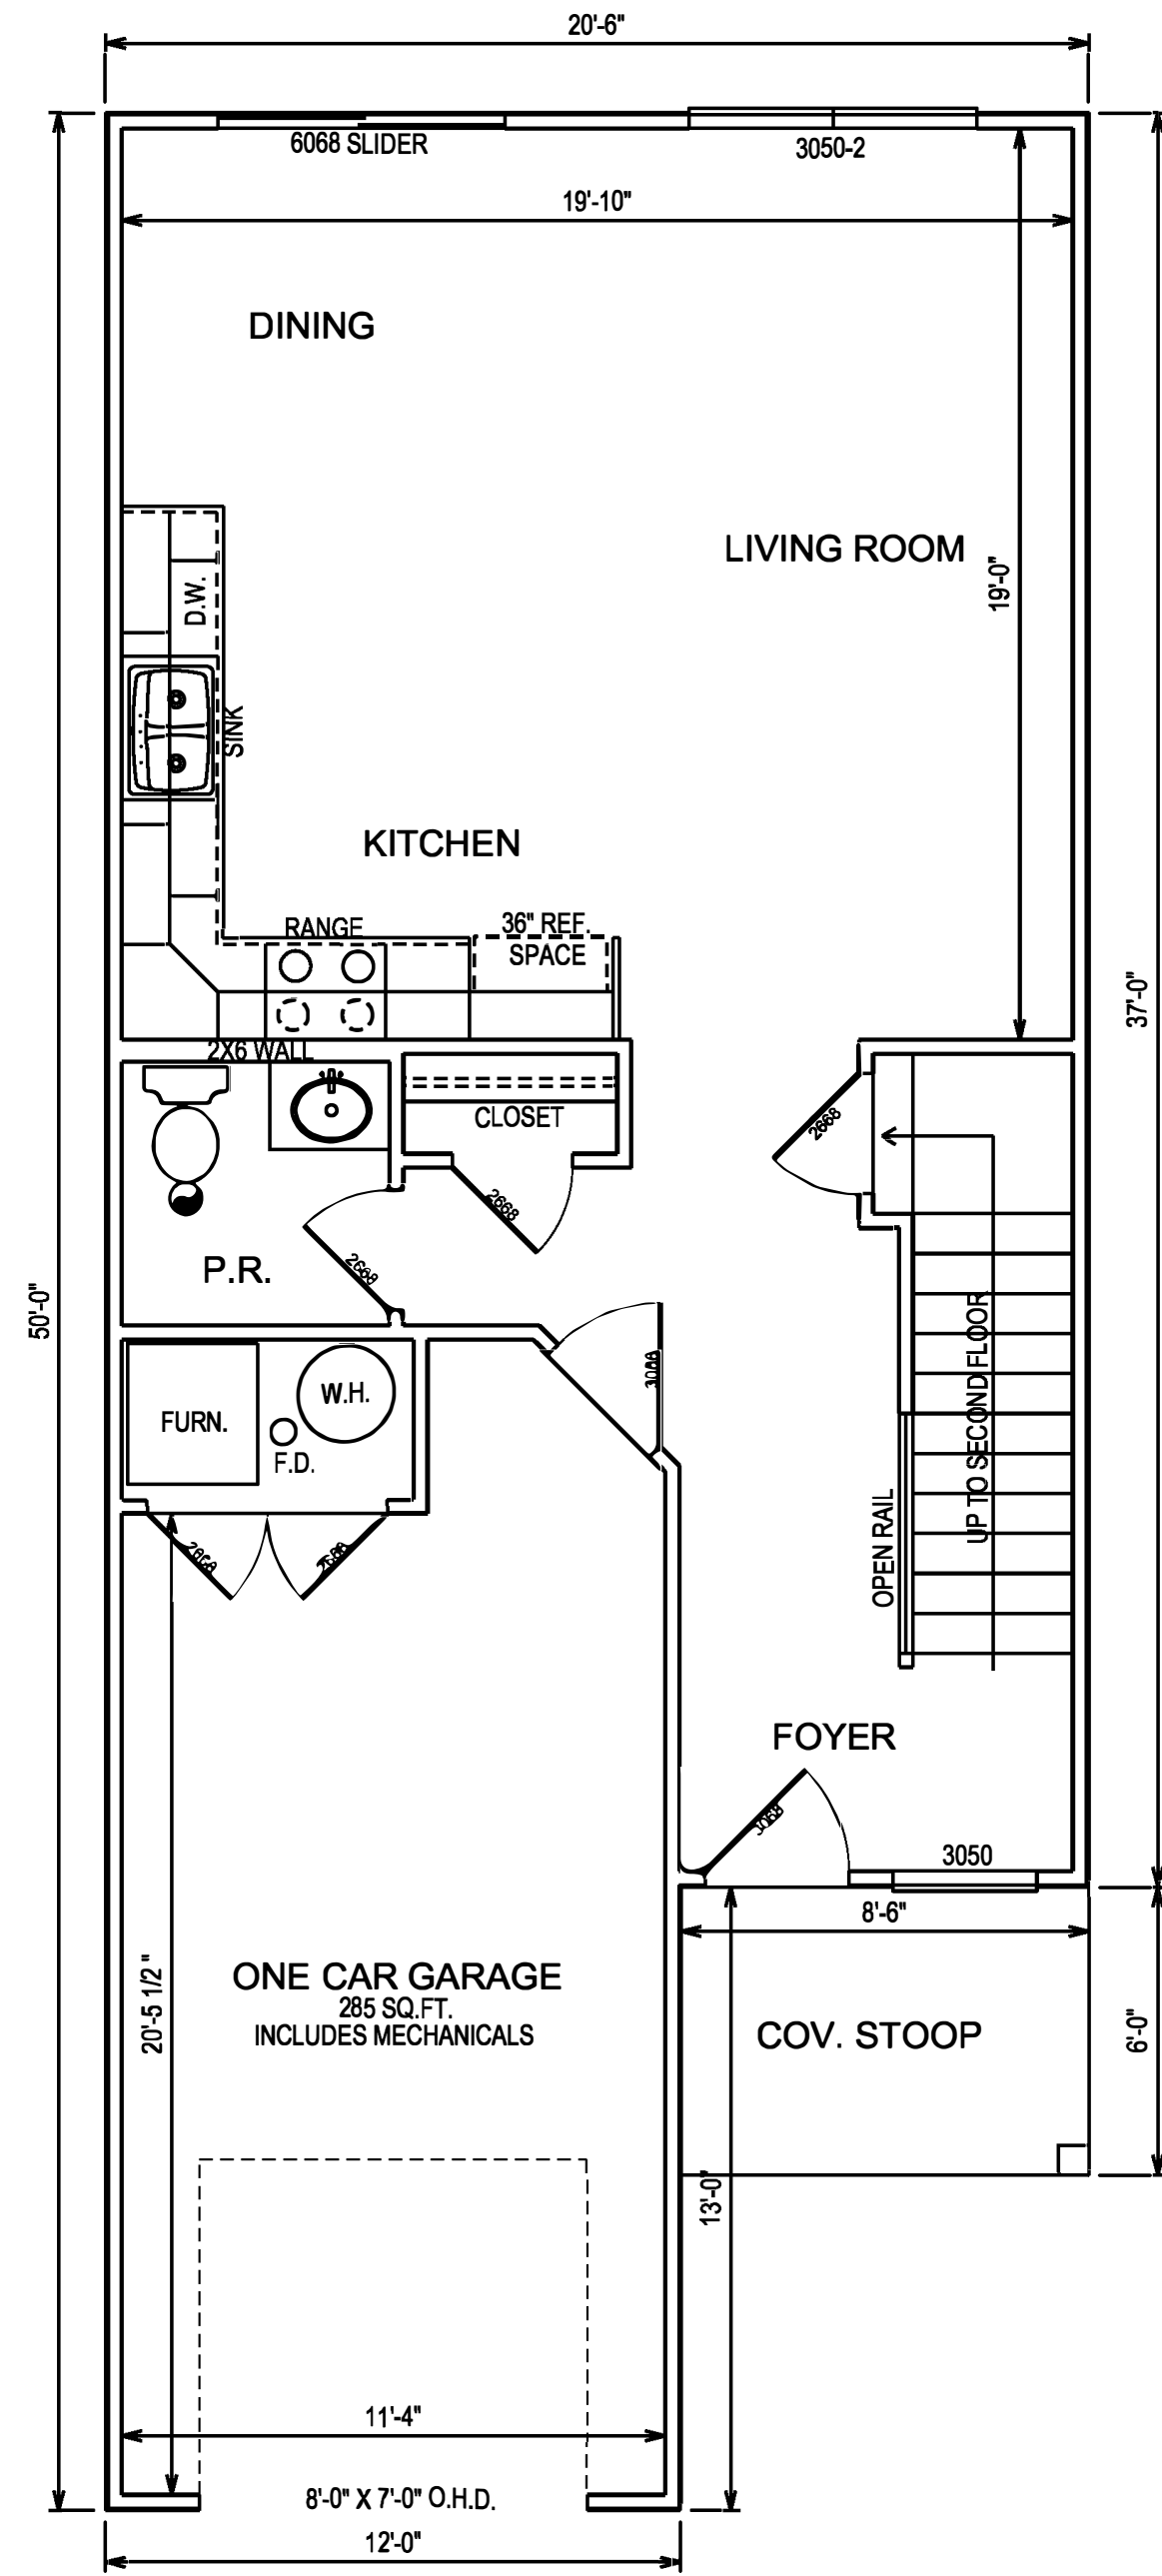

- FIRST FLOOR PLAN -
630 SQ.FT.
8'-0" CEILING HEIGHT

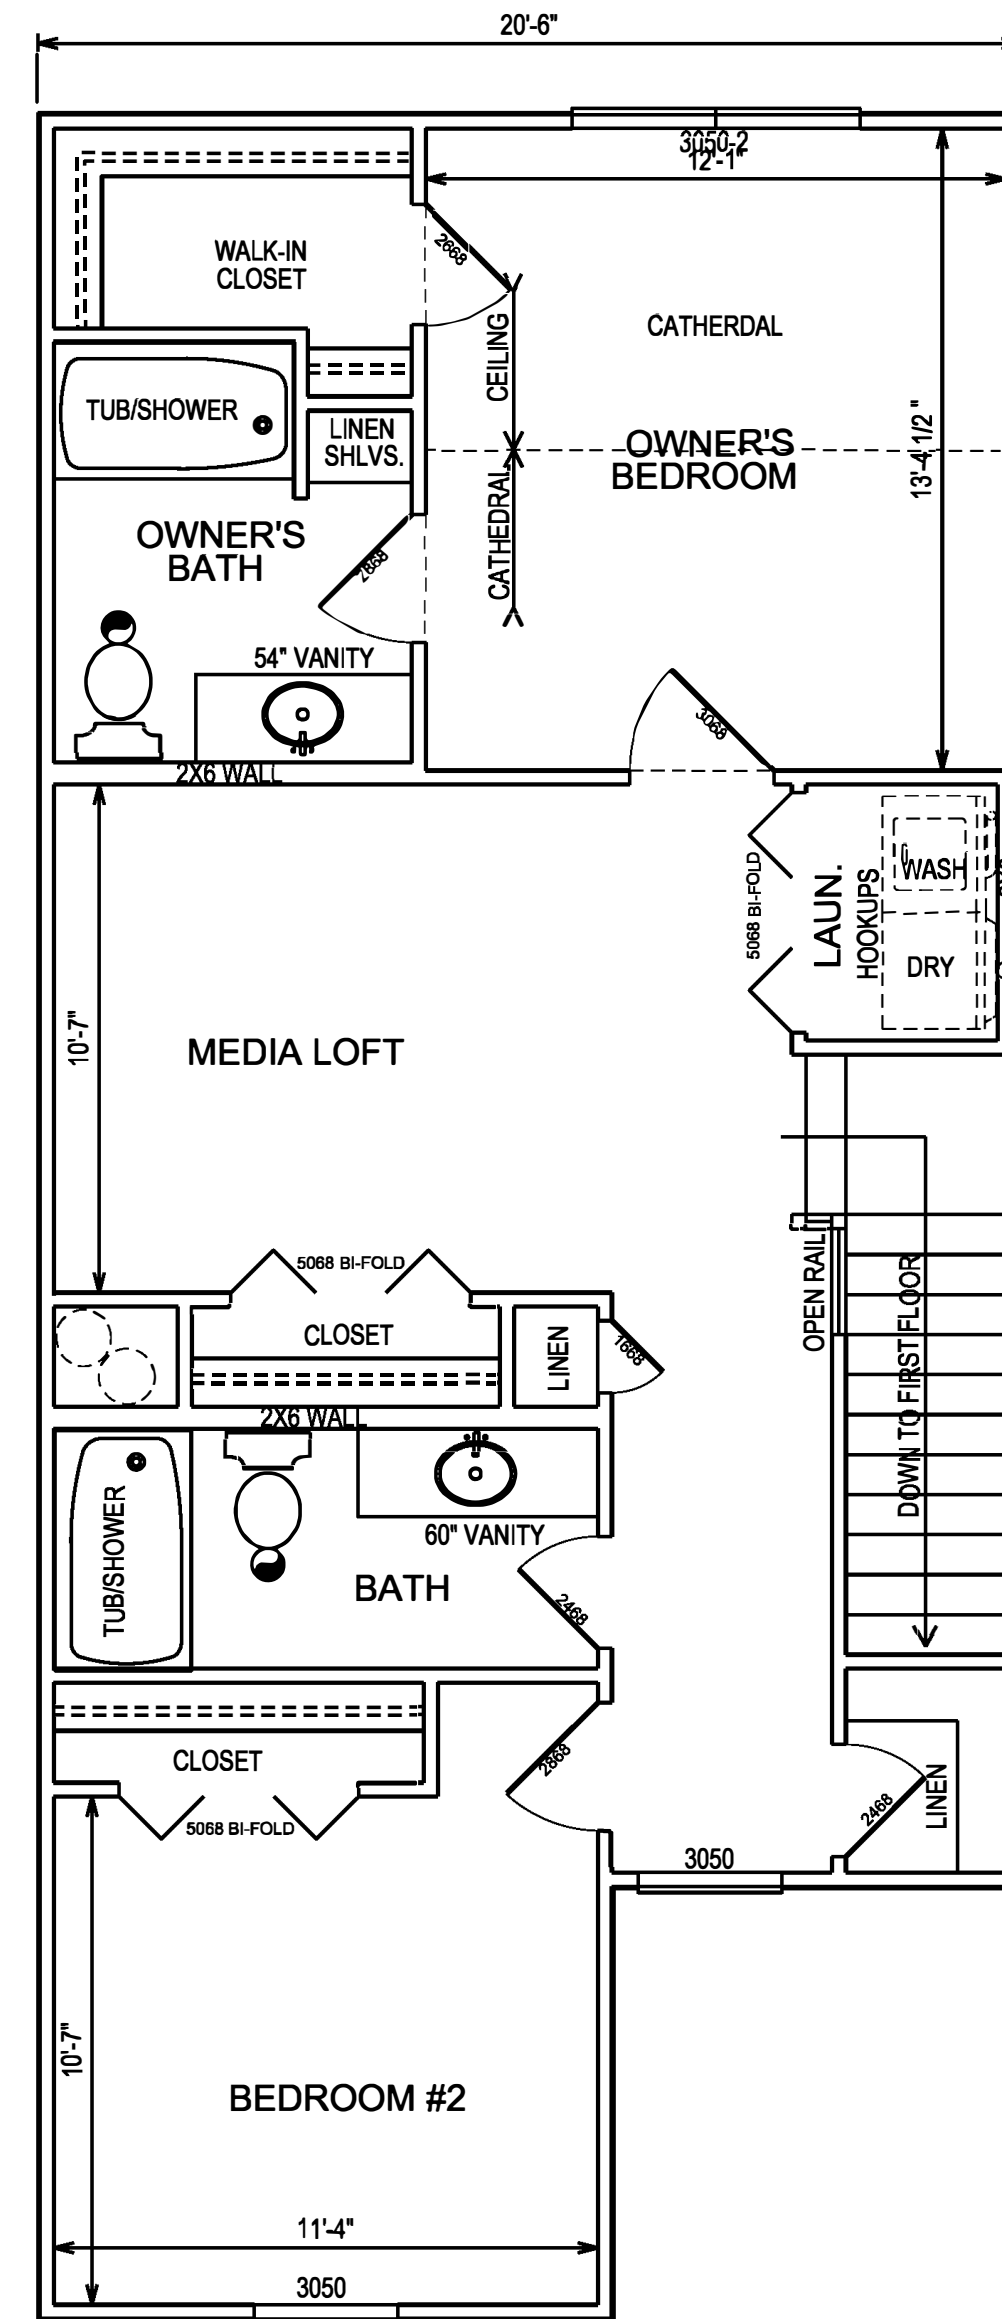

- SECOND FLOOR PLAN -
813 SQ.FT.
8'-0" CEILING HEIGHT

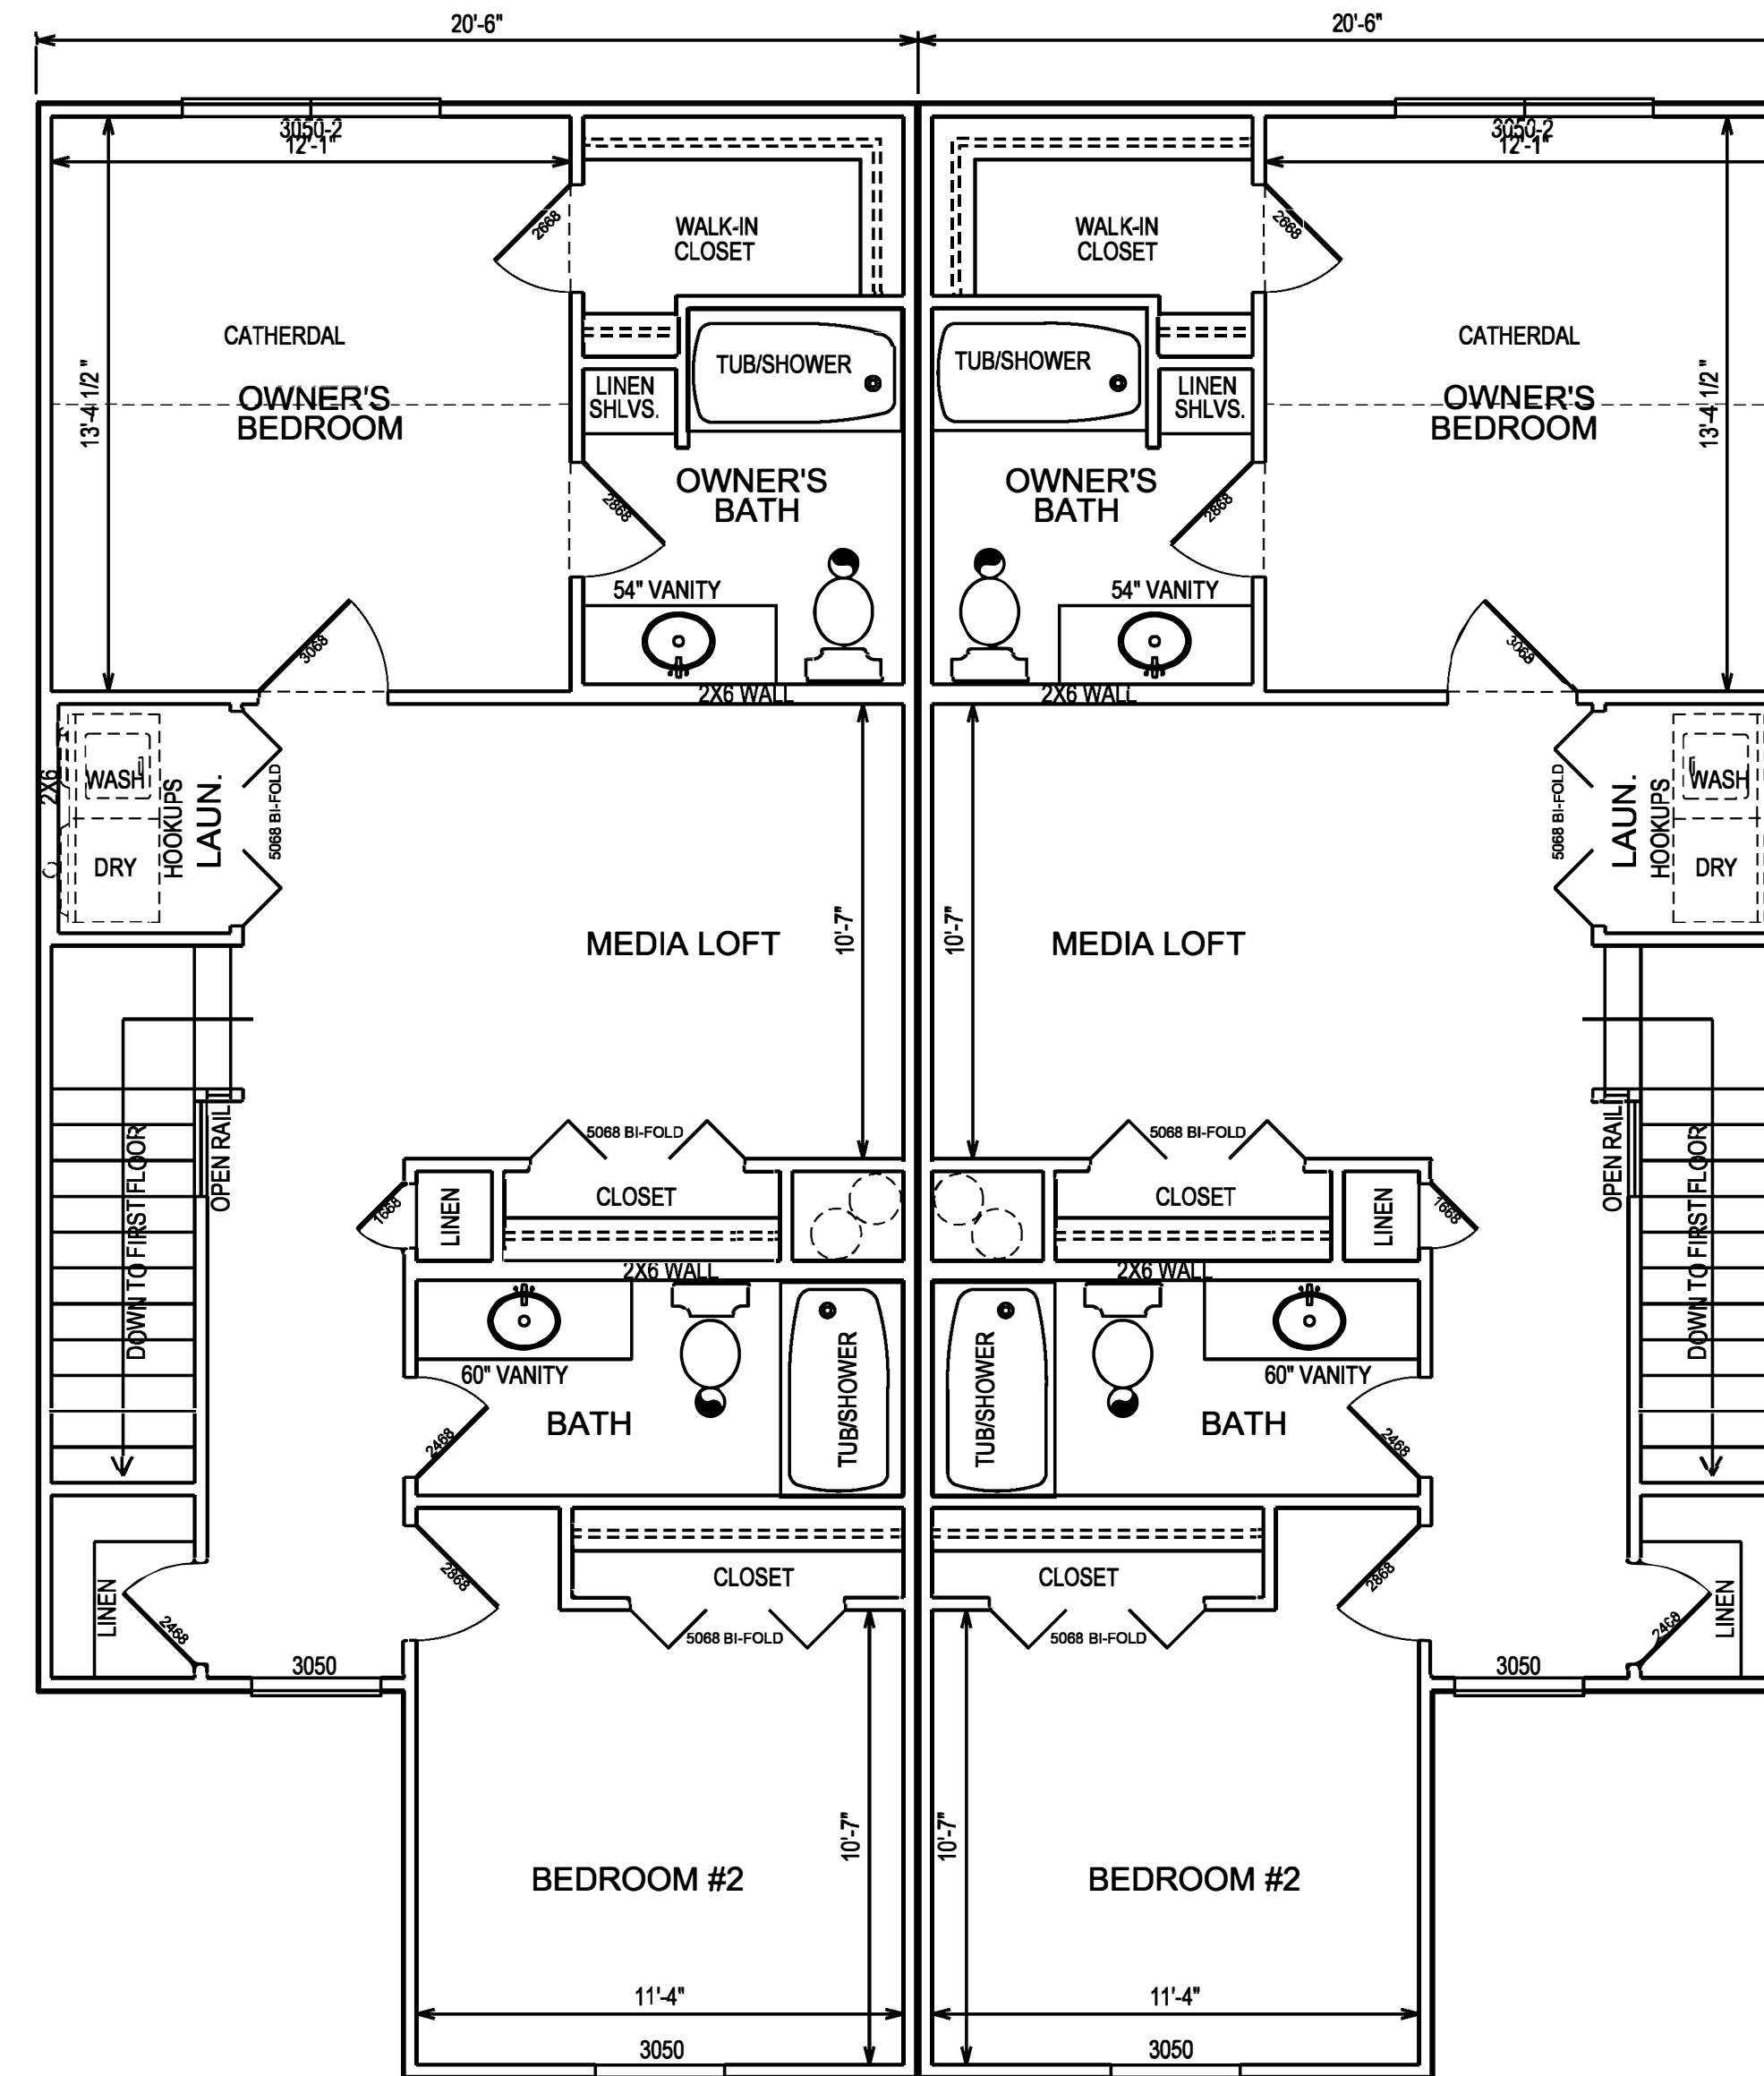

- SECOND FLOOR PLAN -
813 SQ.FT.
8'-0" CEILING HEIGHT

- SECOND FLOOR PLAN -
813 SQ.FT.
8'-0" CEILING HEIGHT


DRAWING #

PRELIMINARY PLANS FOR
2 BEDROOM/2 1/2 BATH
FULLENKAMP DUPLEXES
NEWPORT VILLAGE


DATE:
PHASE 1
2-5-2024
2-16-2024
PHASE 2
2-27-2024

SCALE:
1/4" = 1'-0"


DRAWN BY:
C. ALAN
HARSHMAN

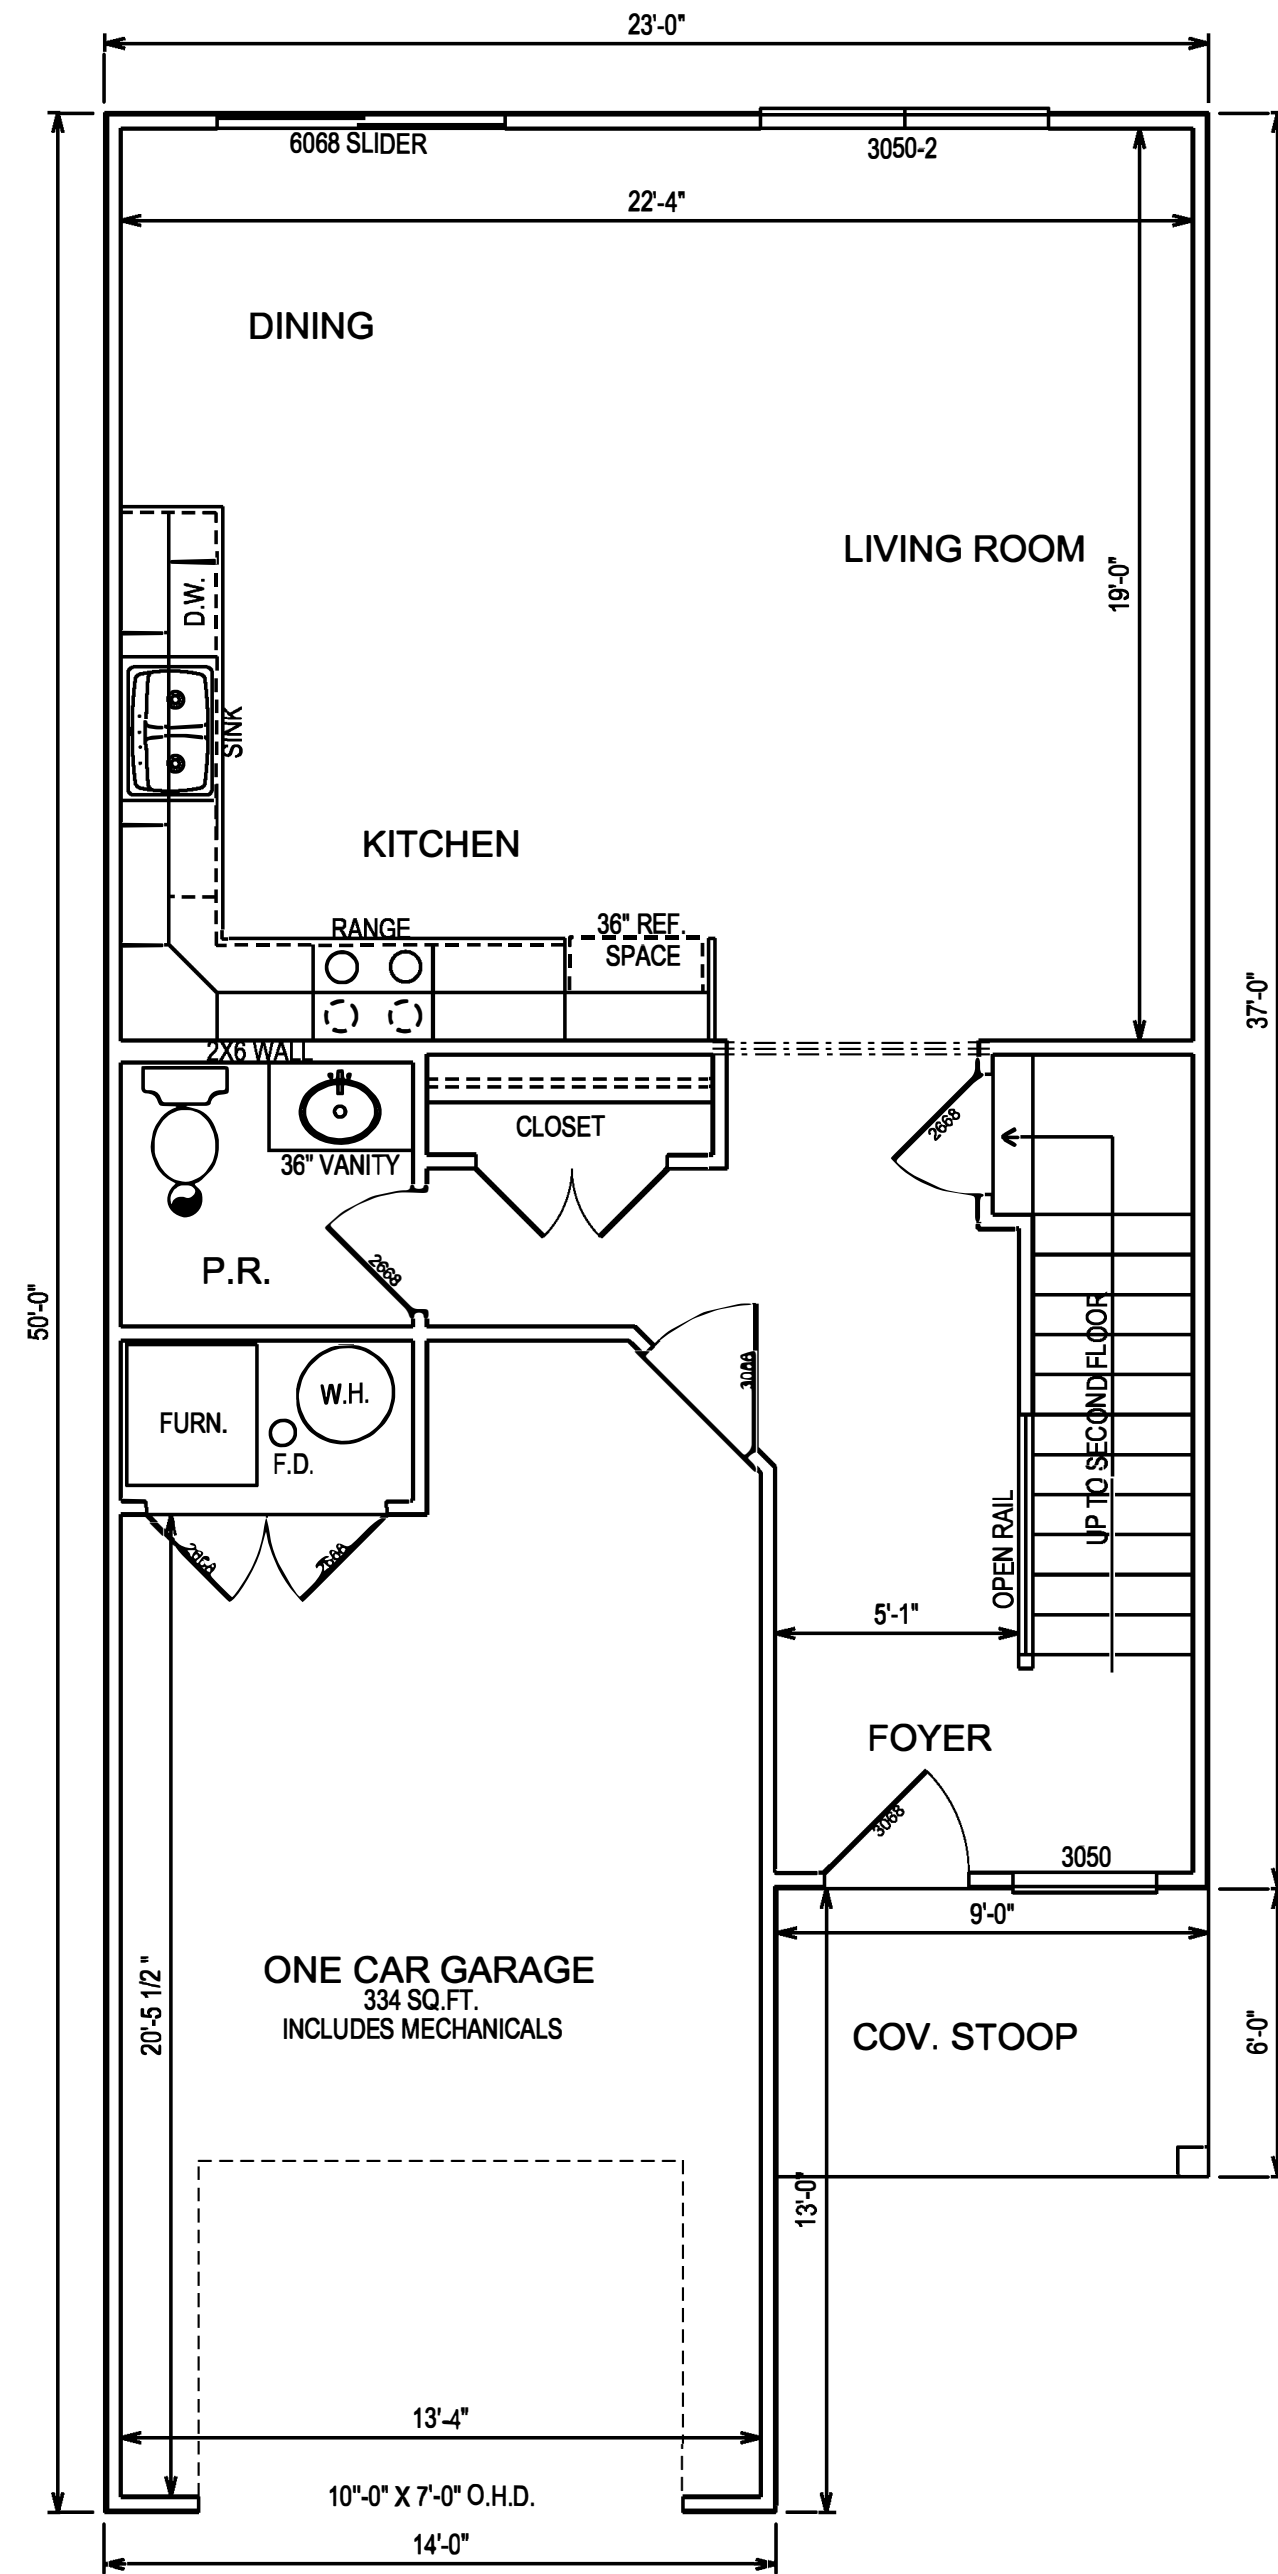

UNIT B
- FIRST FLOOR PLAN -
700 SQ.FT.
8'-0" CEILING HEIGHT

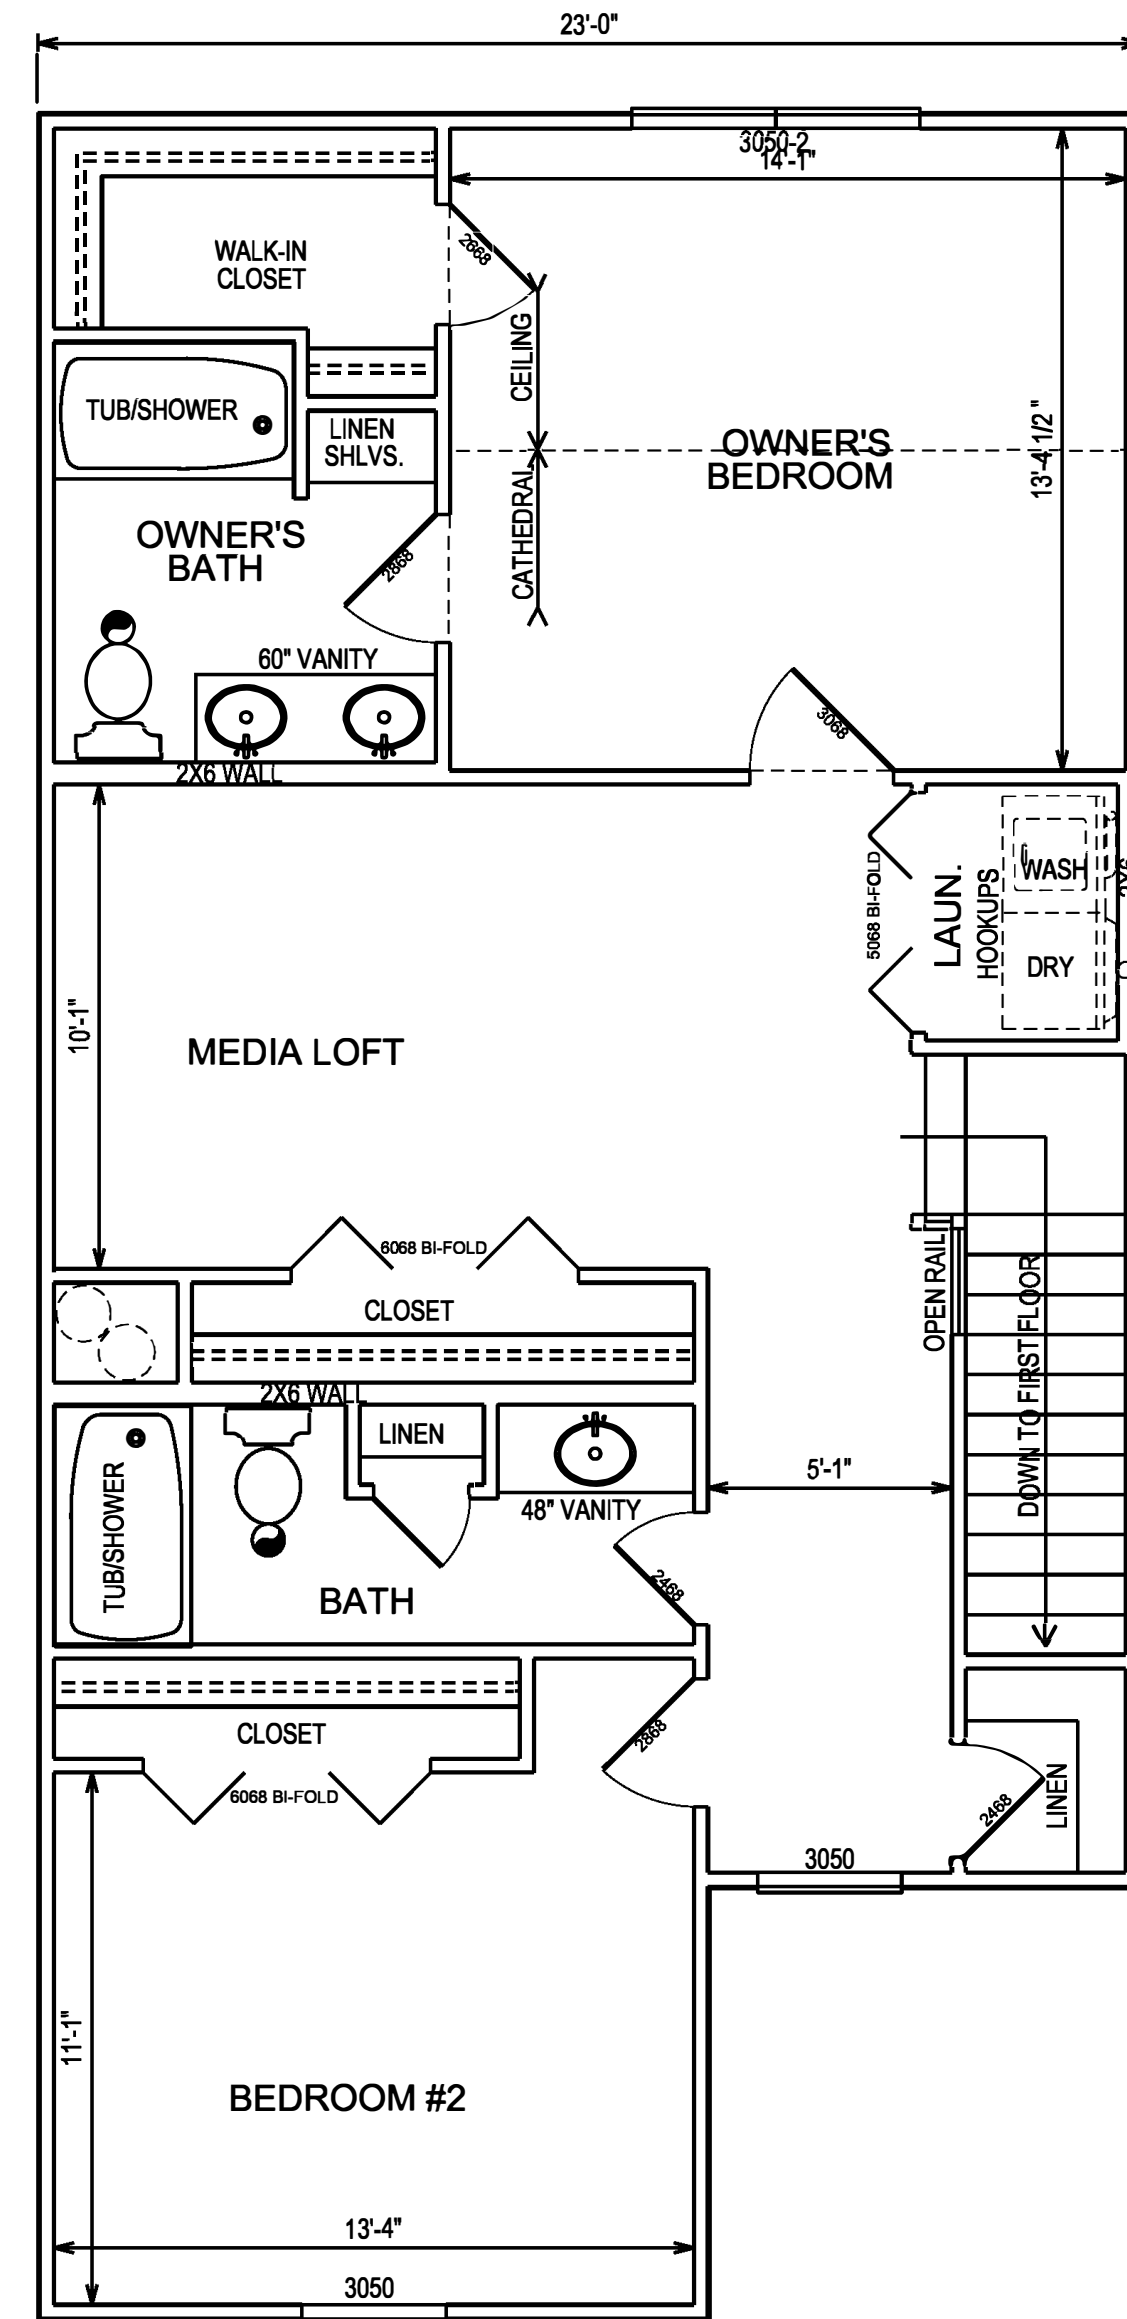

UNIT B
- SECOND FLOOR PLAN -
924 SQ.FT.
8'-0" CEILING HEIGHT

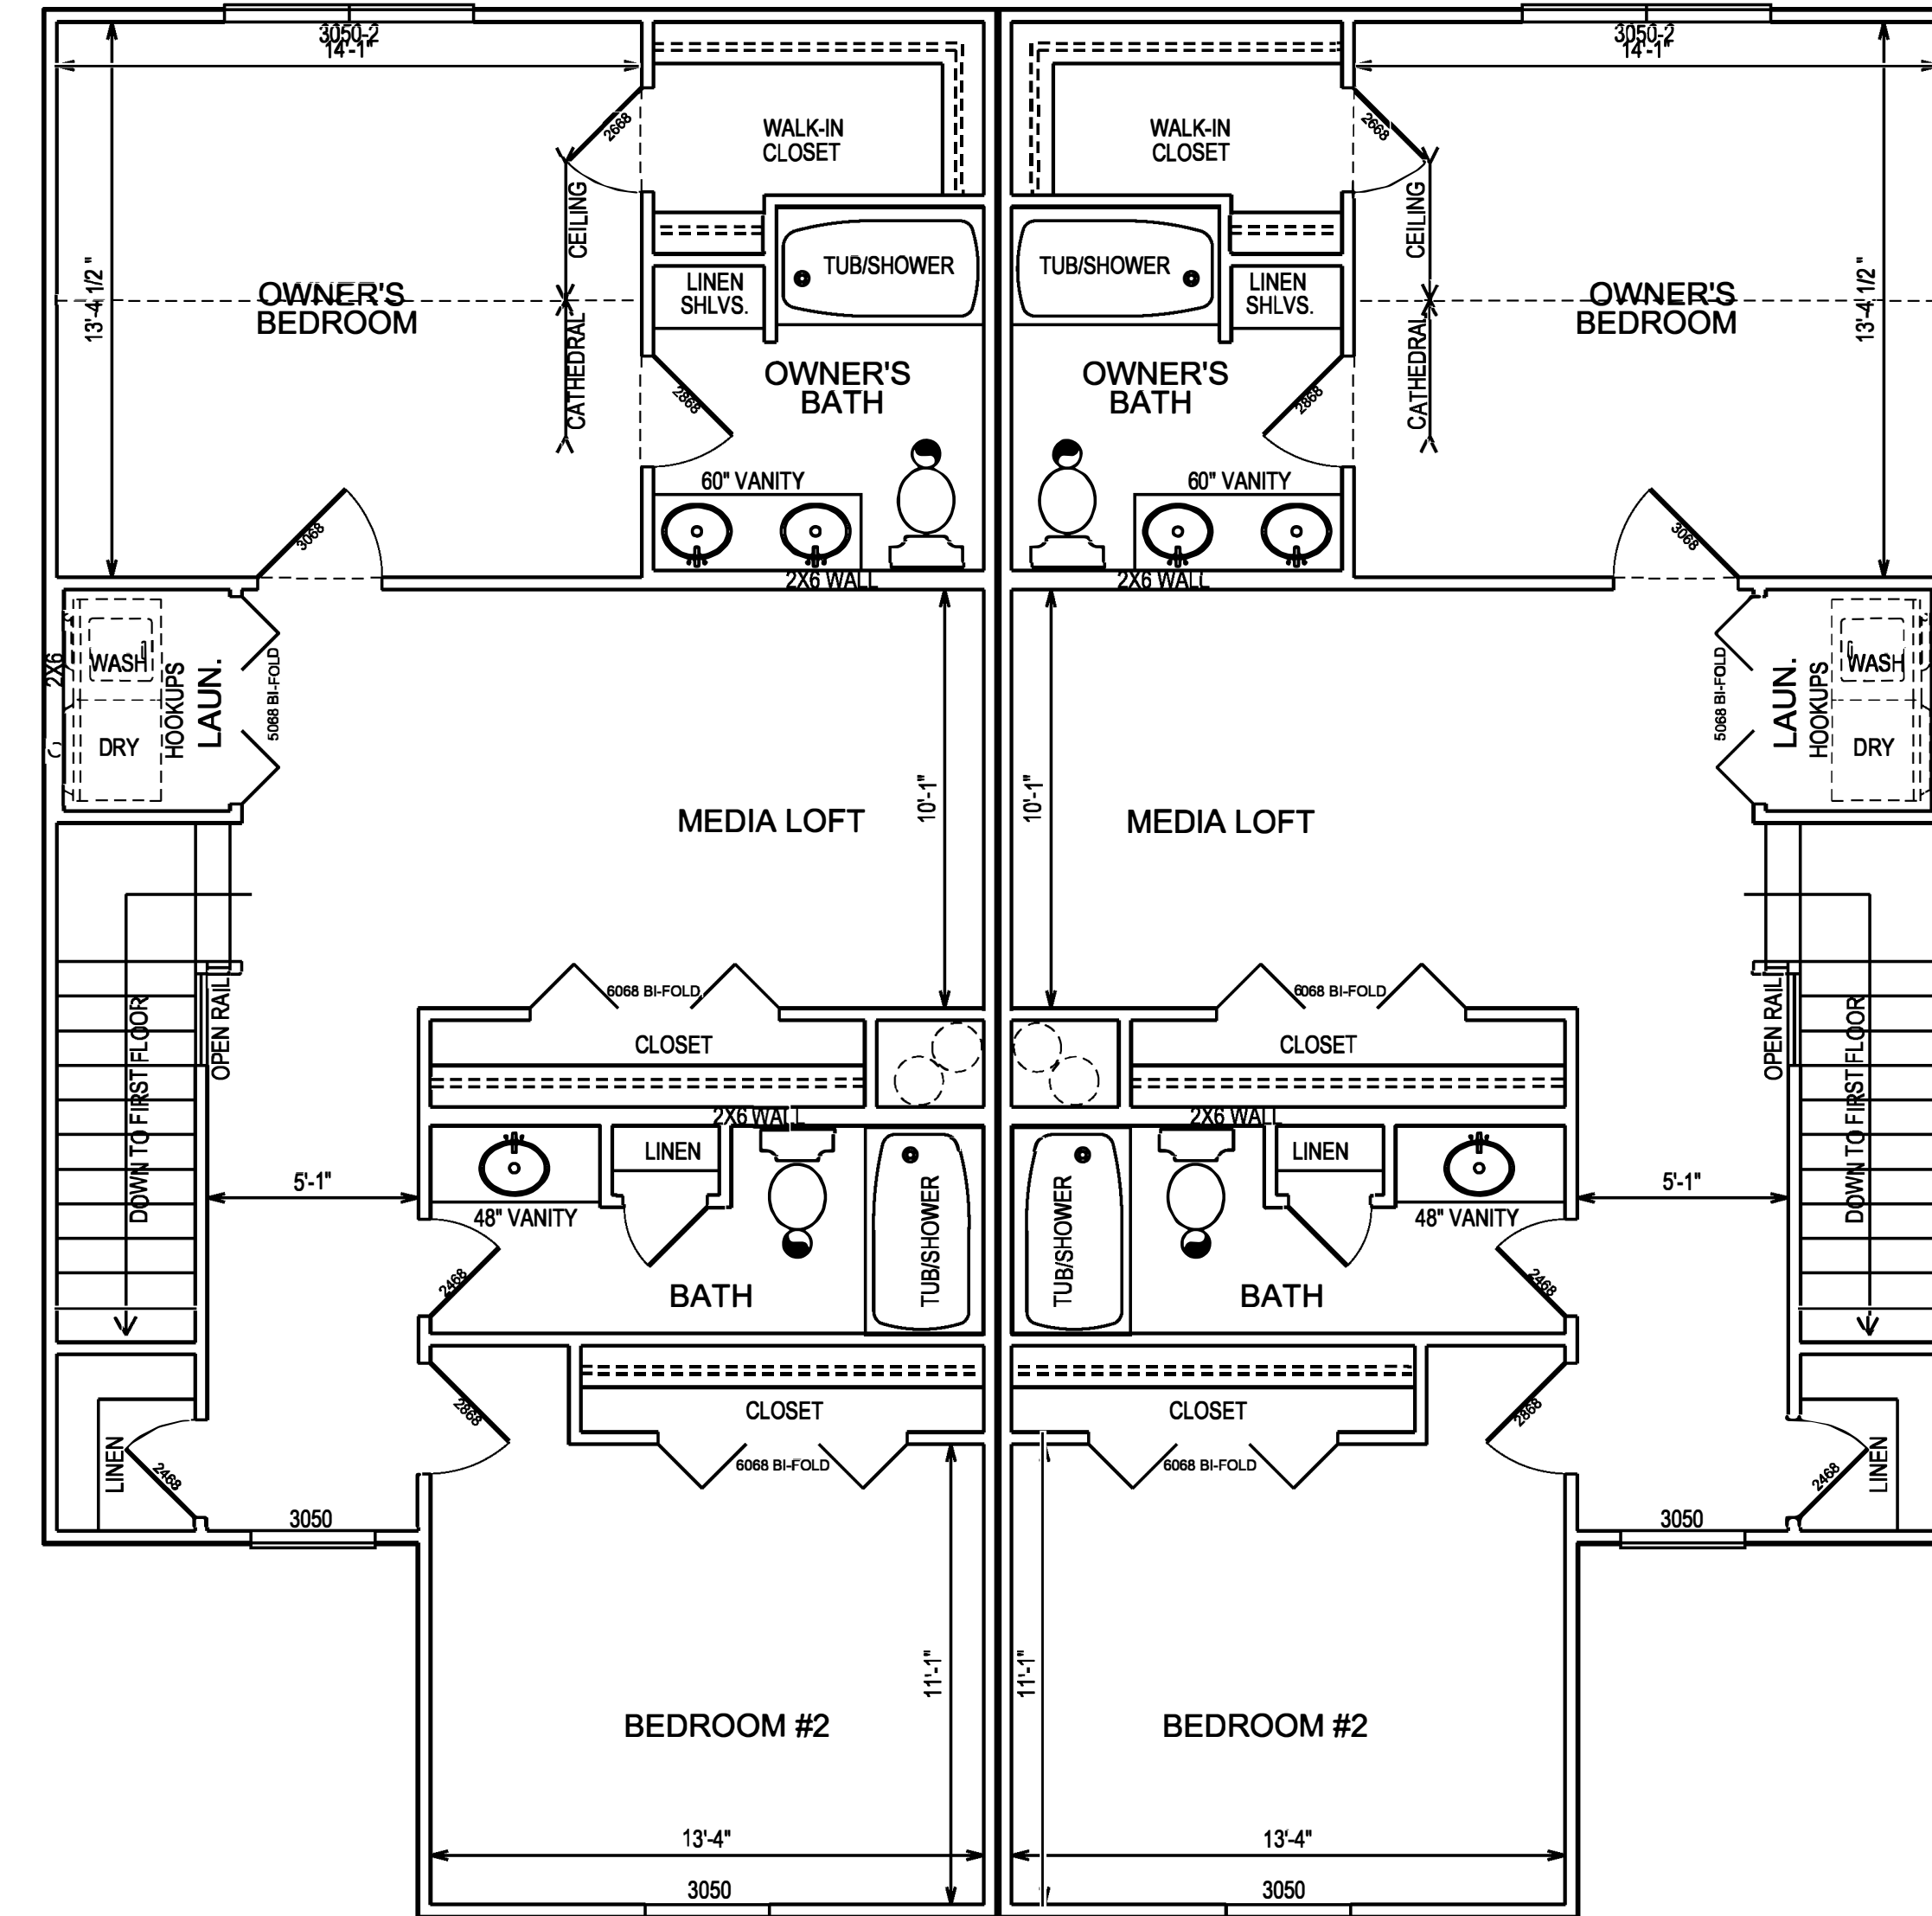

UNIT B
- SECOND FLOOR PLAN -
924 SQ.FT.
8'-0" CEILING HEIGHT

UNIT B
- SECOND FLOOR PLAN -
924 SQ.FT.
8'-0" CEILING HEIGHT


DRAWING #

PRELIMINARY PLANS FOR
2 BEDROOM/ 2 1/2 BATH (B)
FULLENKAMP DUPLEXES
NEWPORT VILLAGE

DATE:
PHASE 1
2-5-2024
2-16-2024
PHASE 2
3-8-2024

SCALE:
1/4" = 1'-0"


DRAWN BY:
C. ALAN
HARSHMAN

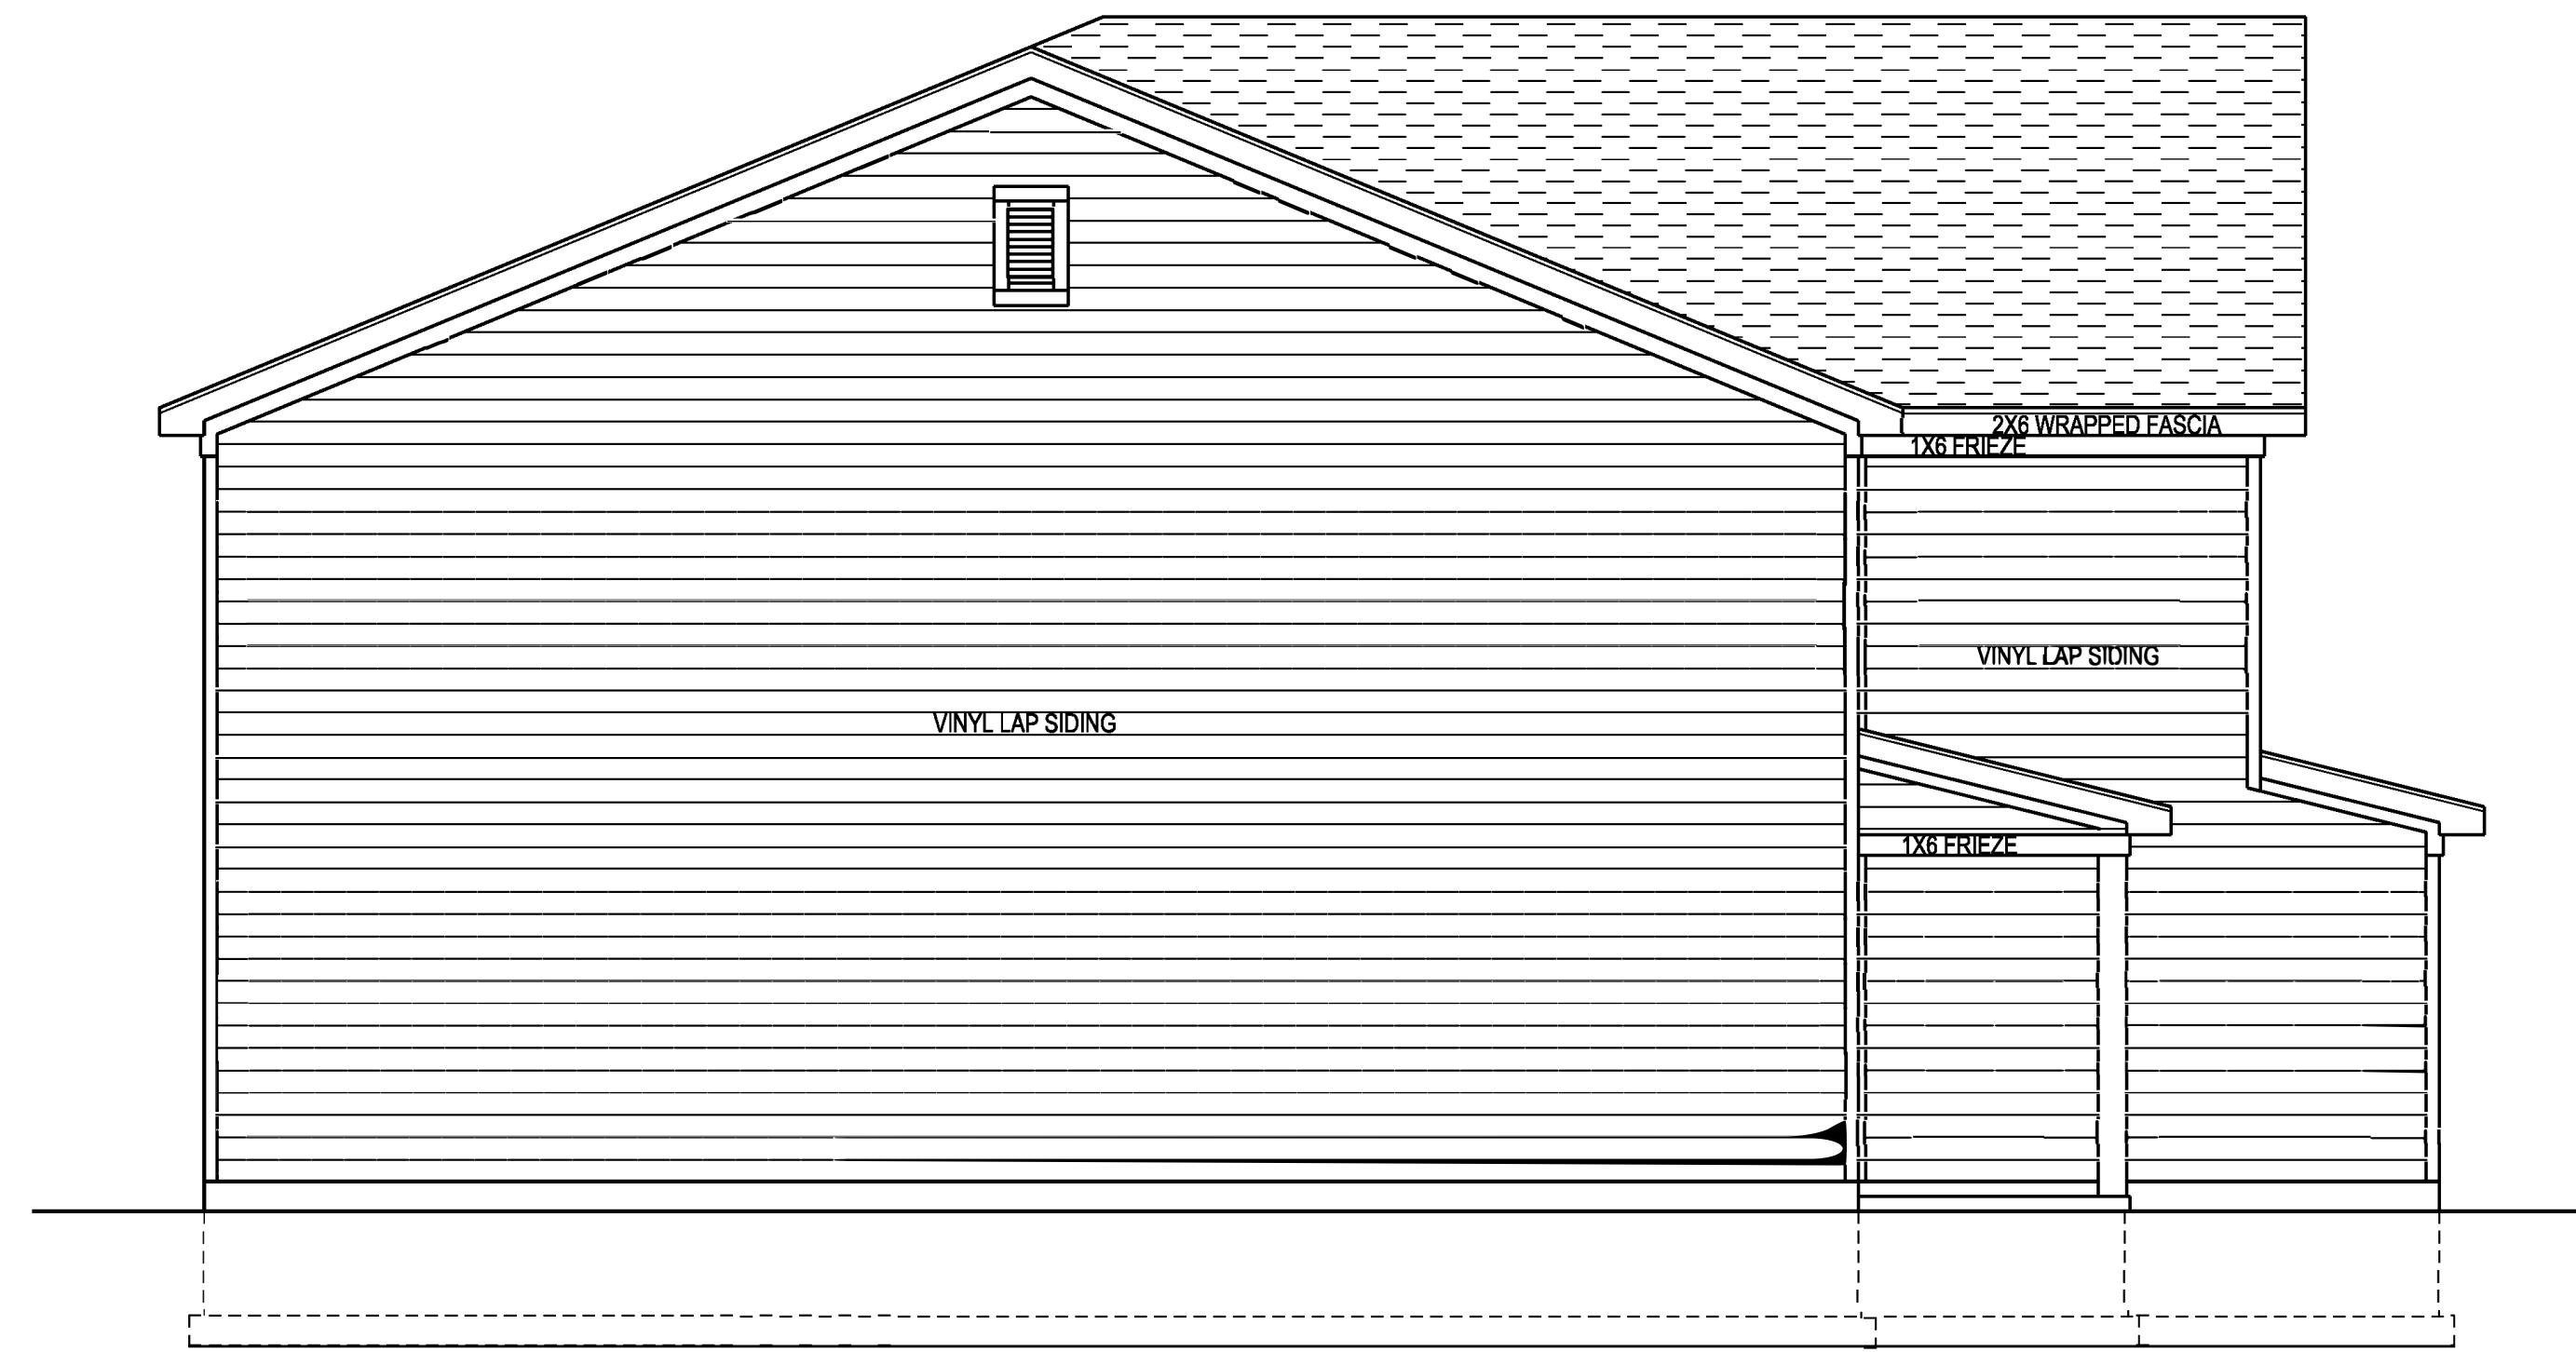


- LEFT ELEVATION -
UNIT B



- FRONT ELEVATION -
UNIT B

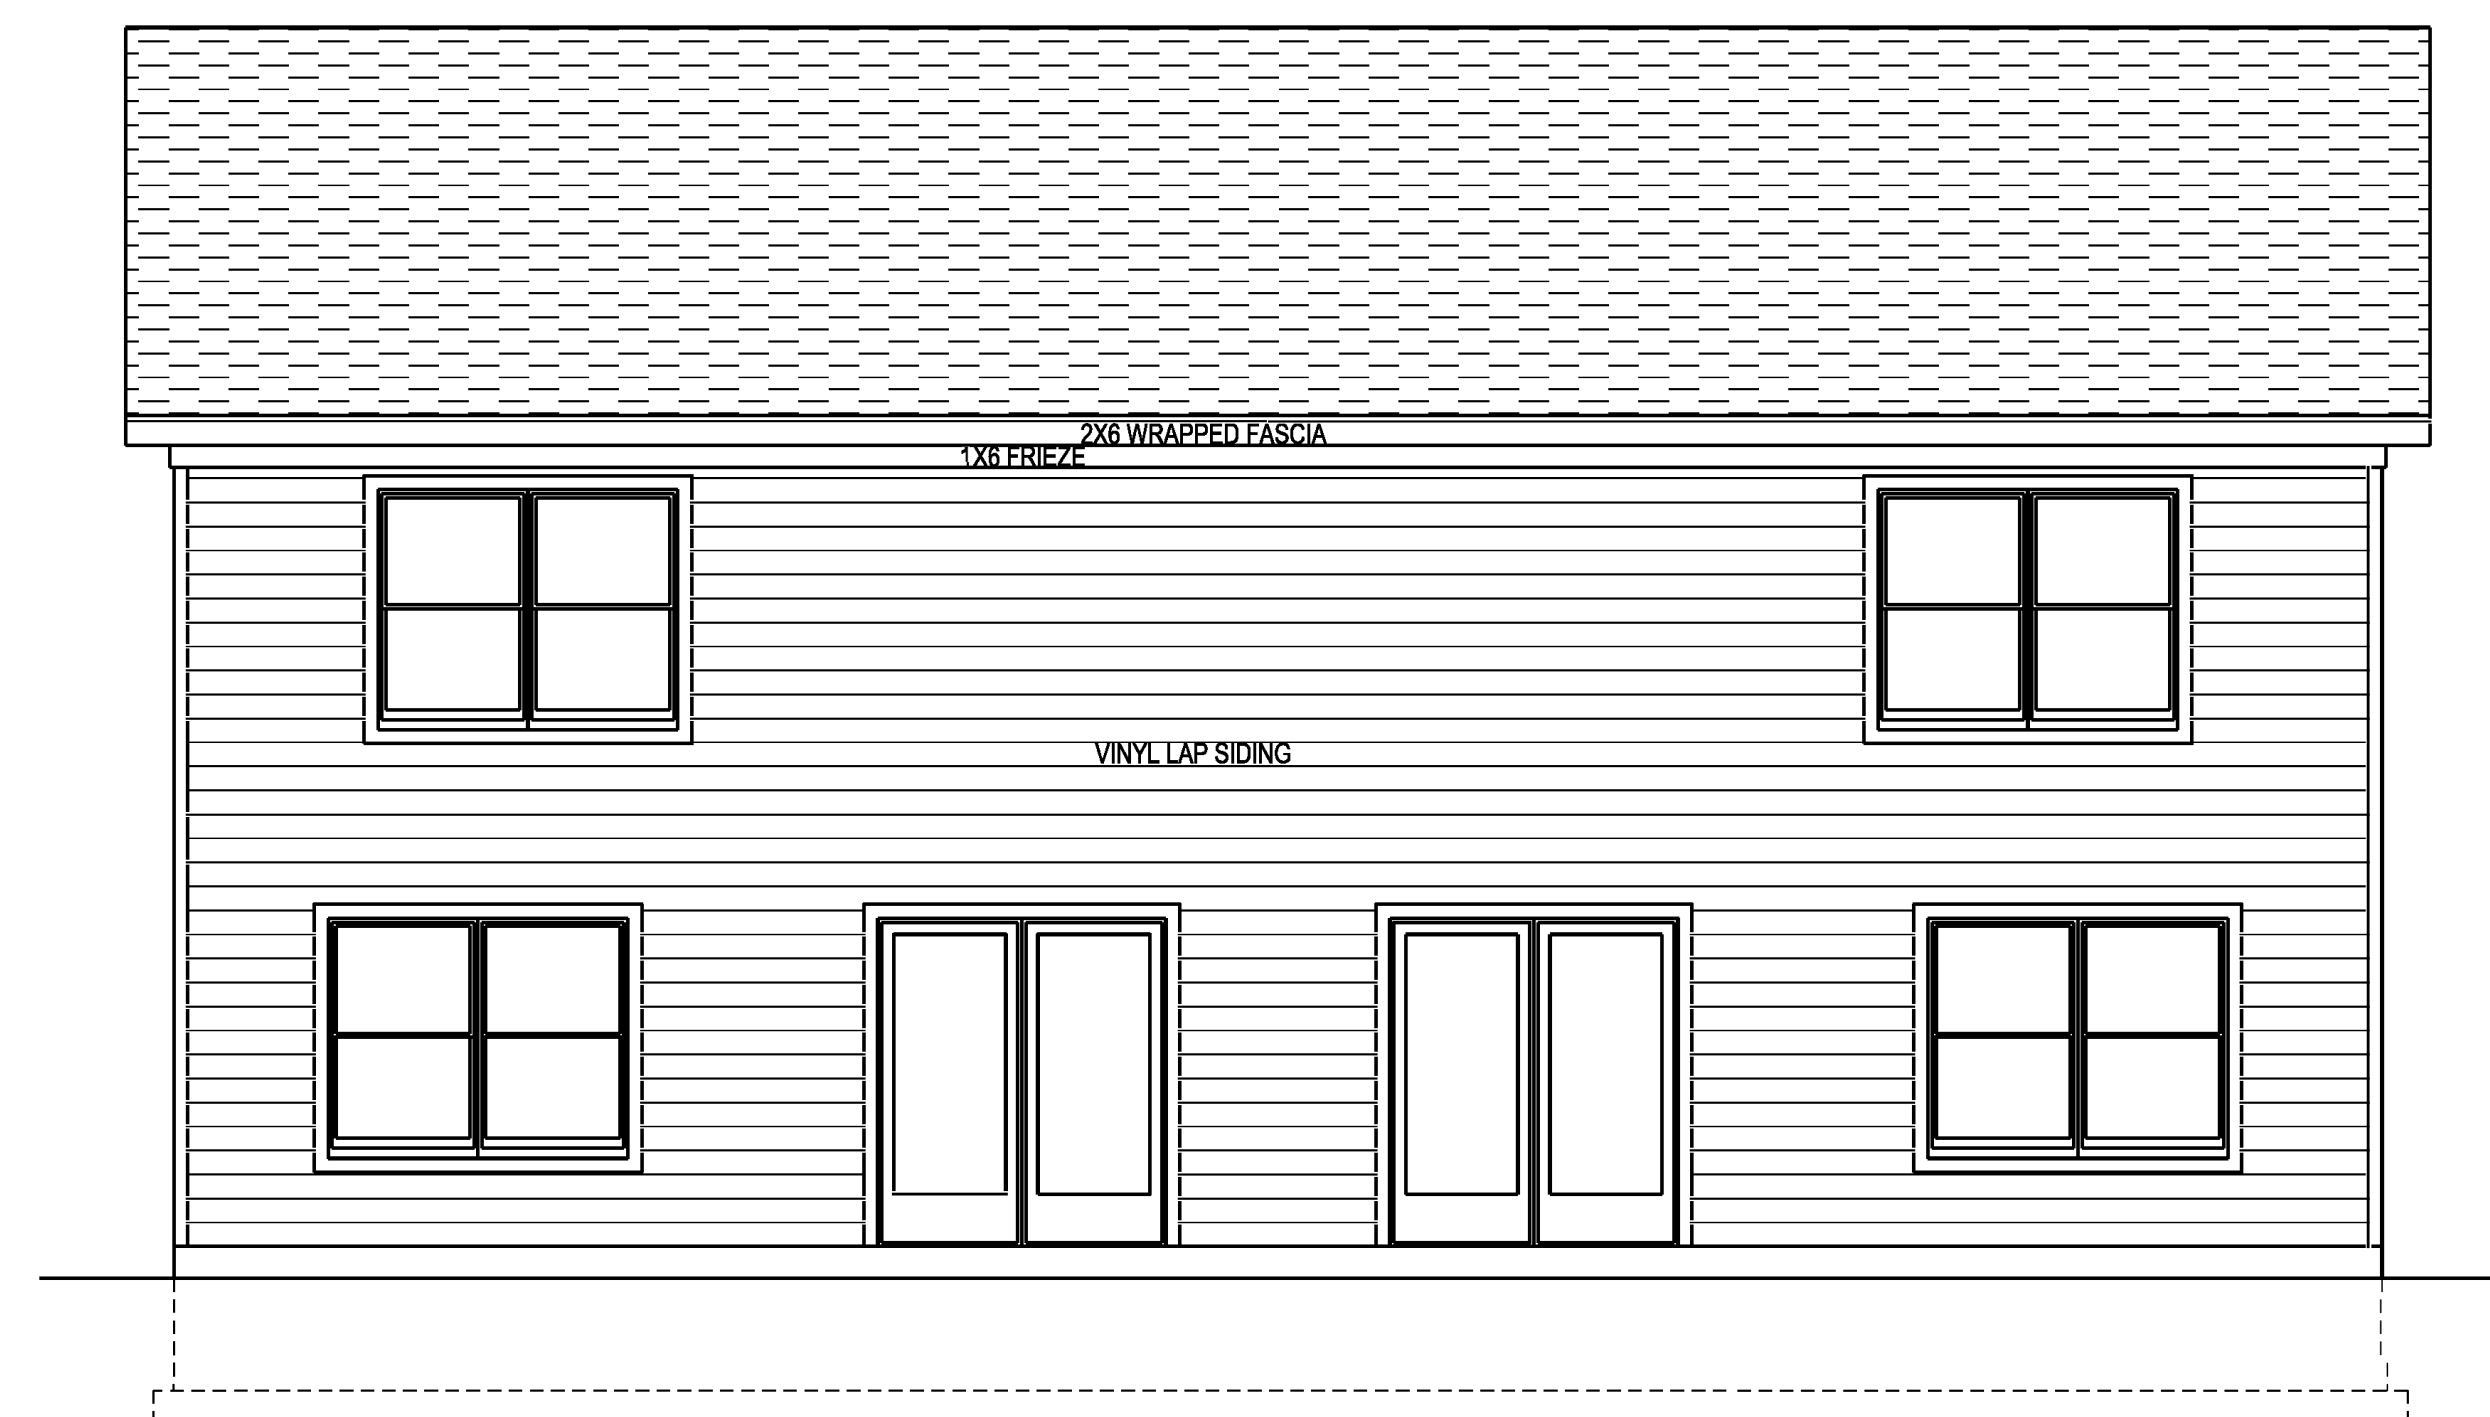

- REAR ELEVATION -
UNIT B

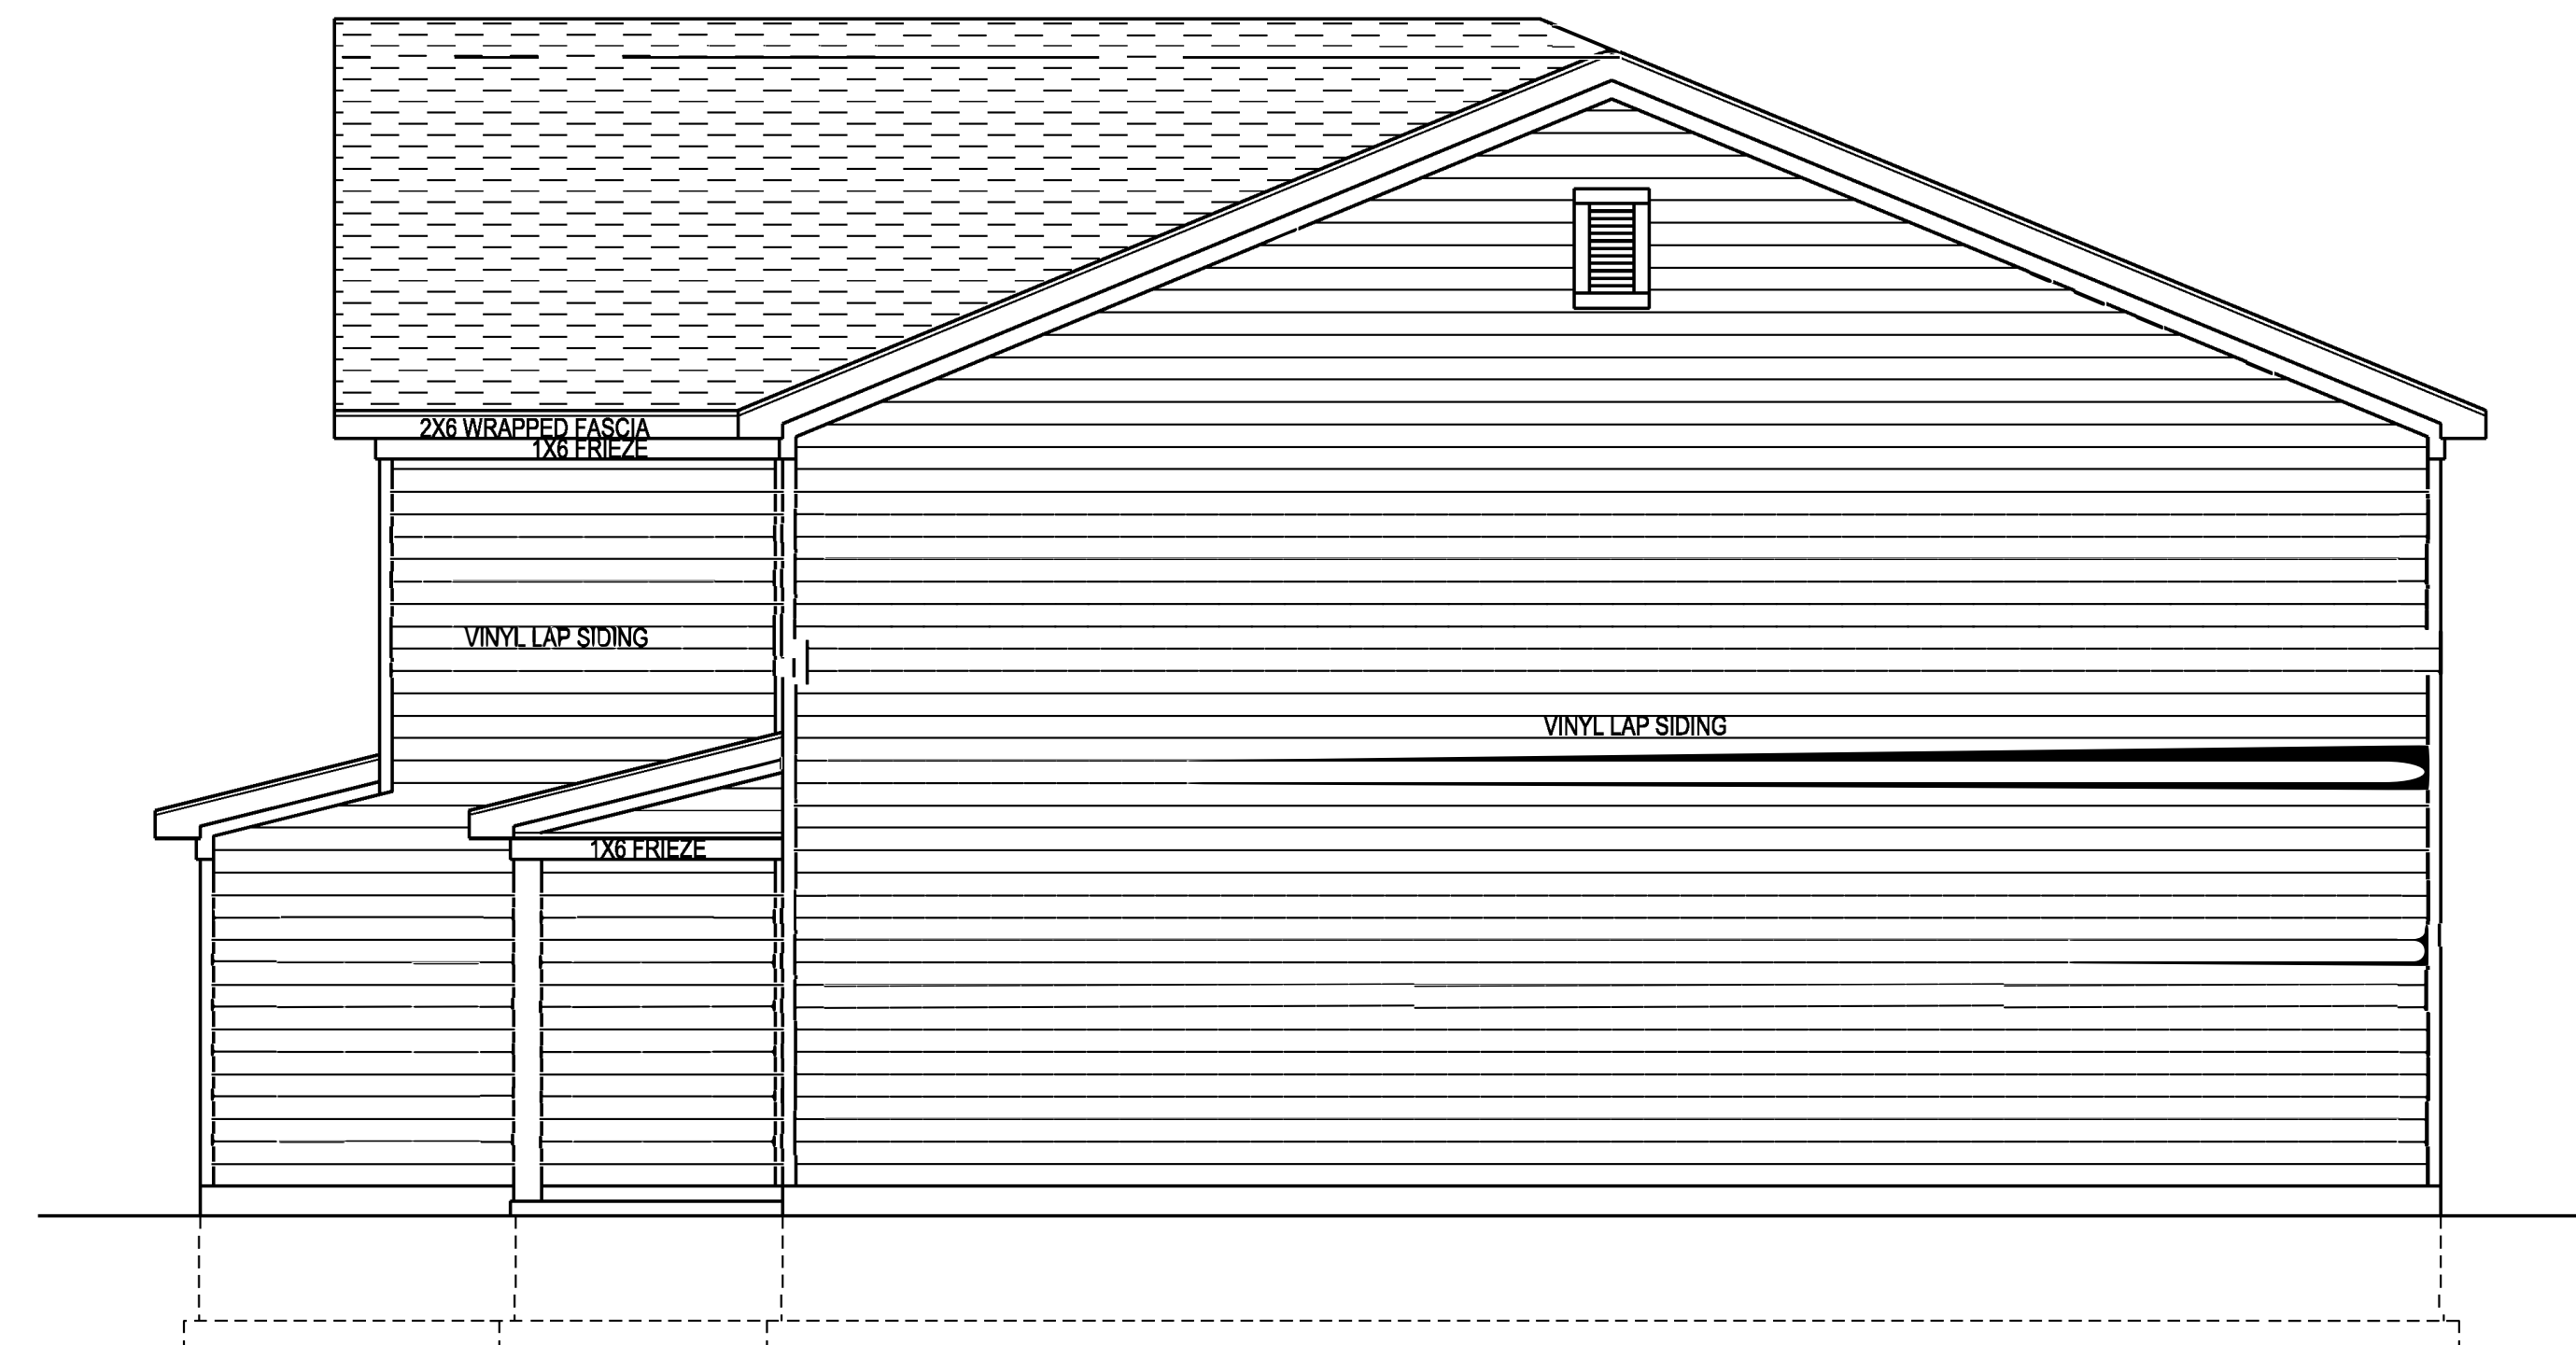

- RIGHT ELEVATION -
UNIT B


DRAWING #

PRELIMINARY PLANS FOR
2 BEDROOM/ 2 1/2 BATH (B)
FULLENKAMP DUPLEXES
NEWPORT VILLAGE

DATE:
PHASE 1
2-5-2024
2-16-2024
PHASE 2
3-8-2024


SCALE:
1/4" = 1'-0"

DRAWN BY:
C. ALAN
HARSHMAN

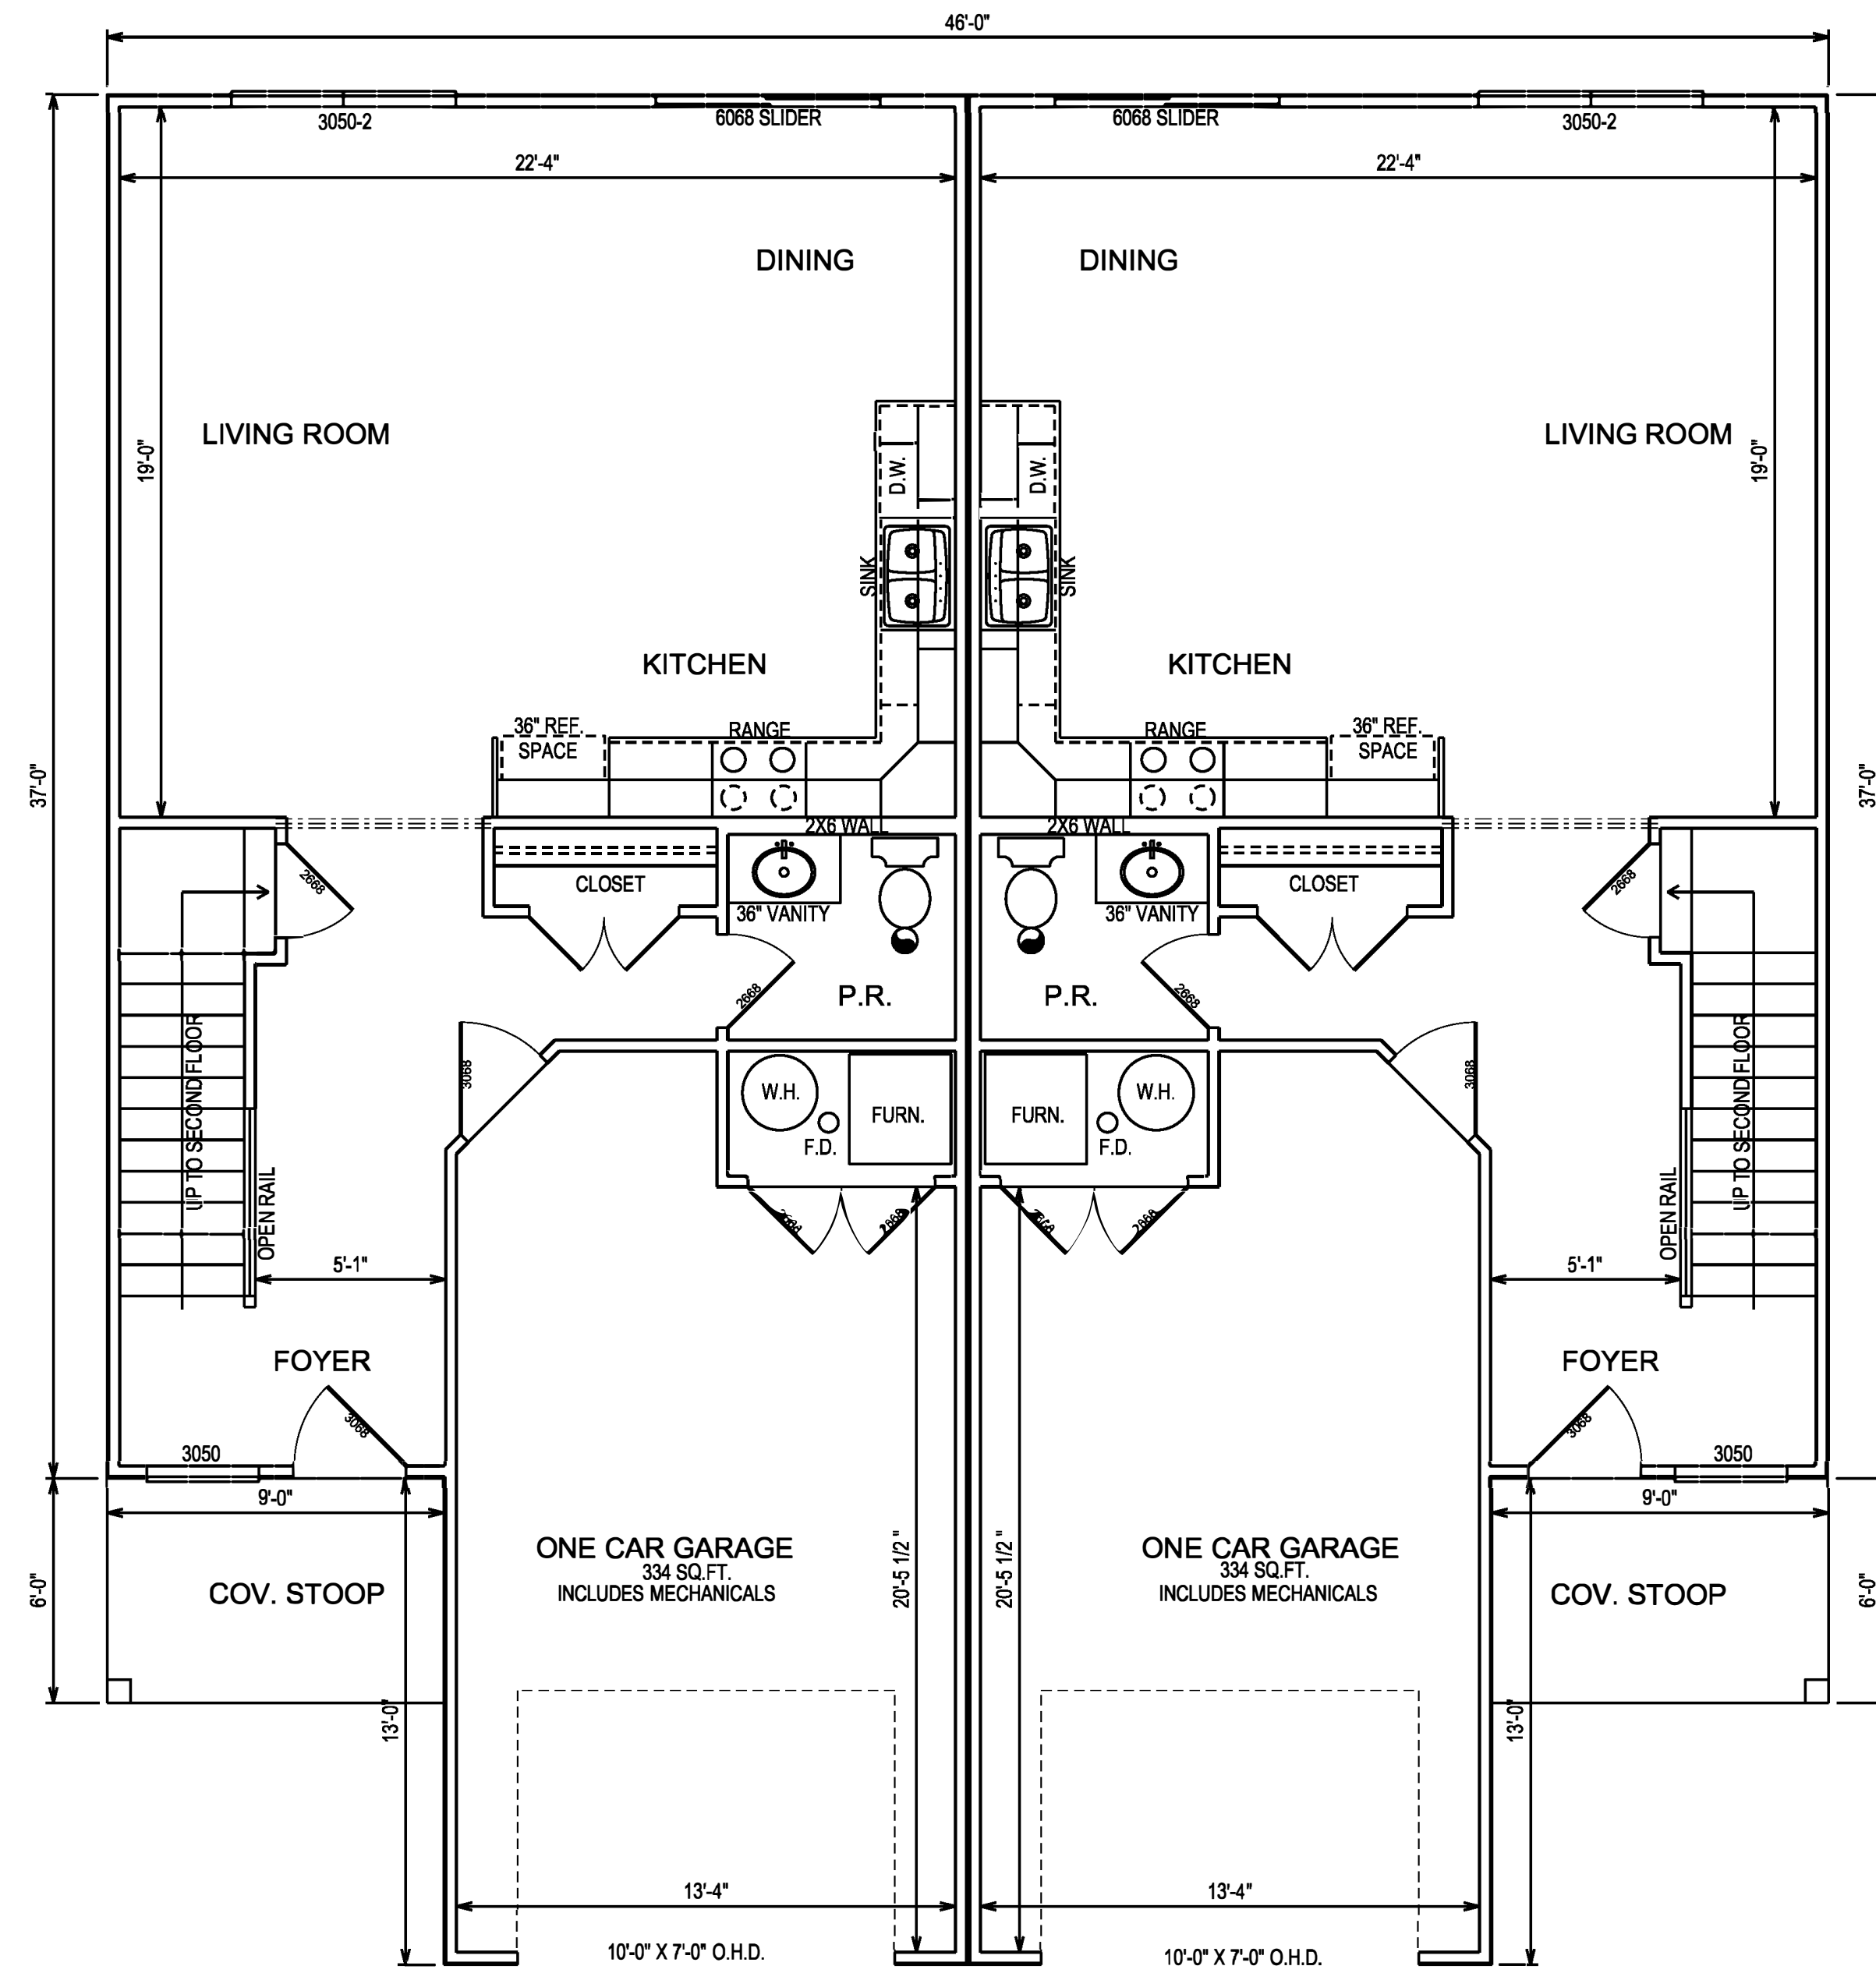

UNIT B
- FIRST FLOOR PLAN -
700 SQ.FT.
8'-0" CEILING HEIGHT

UNIT B
- FIRST FLOOR PLAN -
700 SQ.FT.
8'-0" CEILING HEIGHT

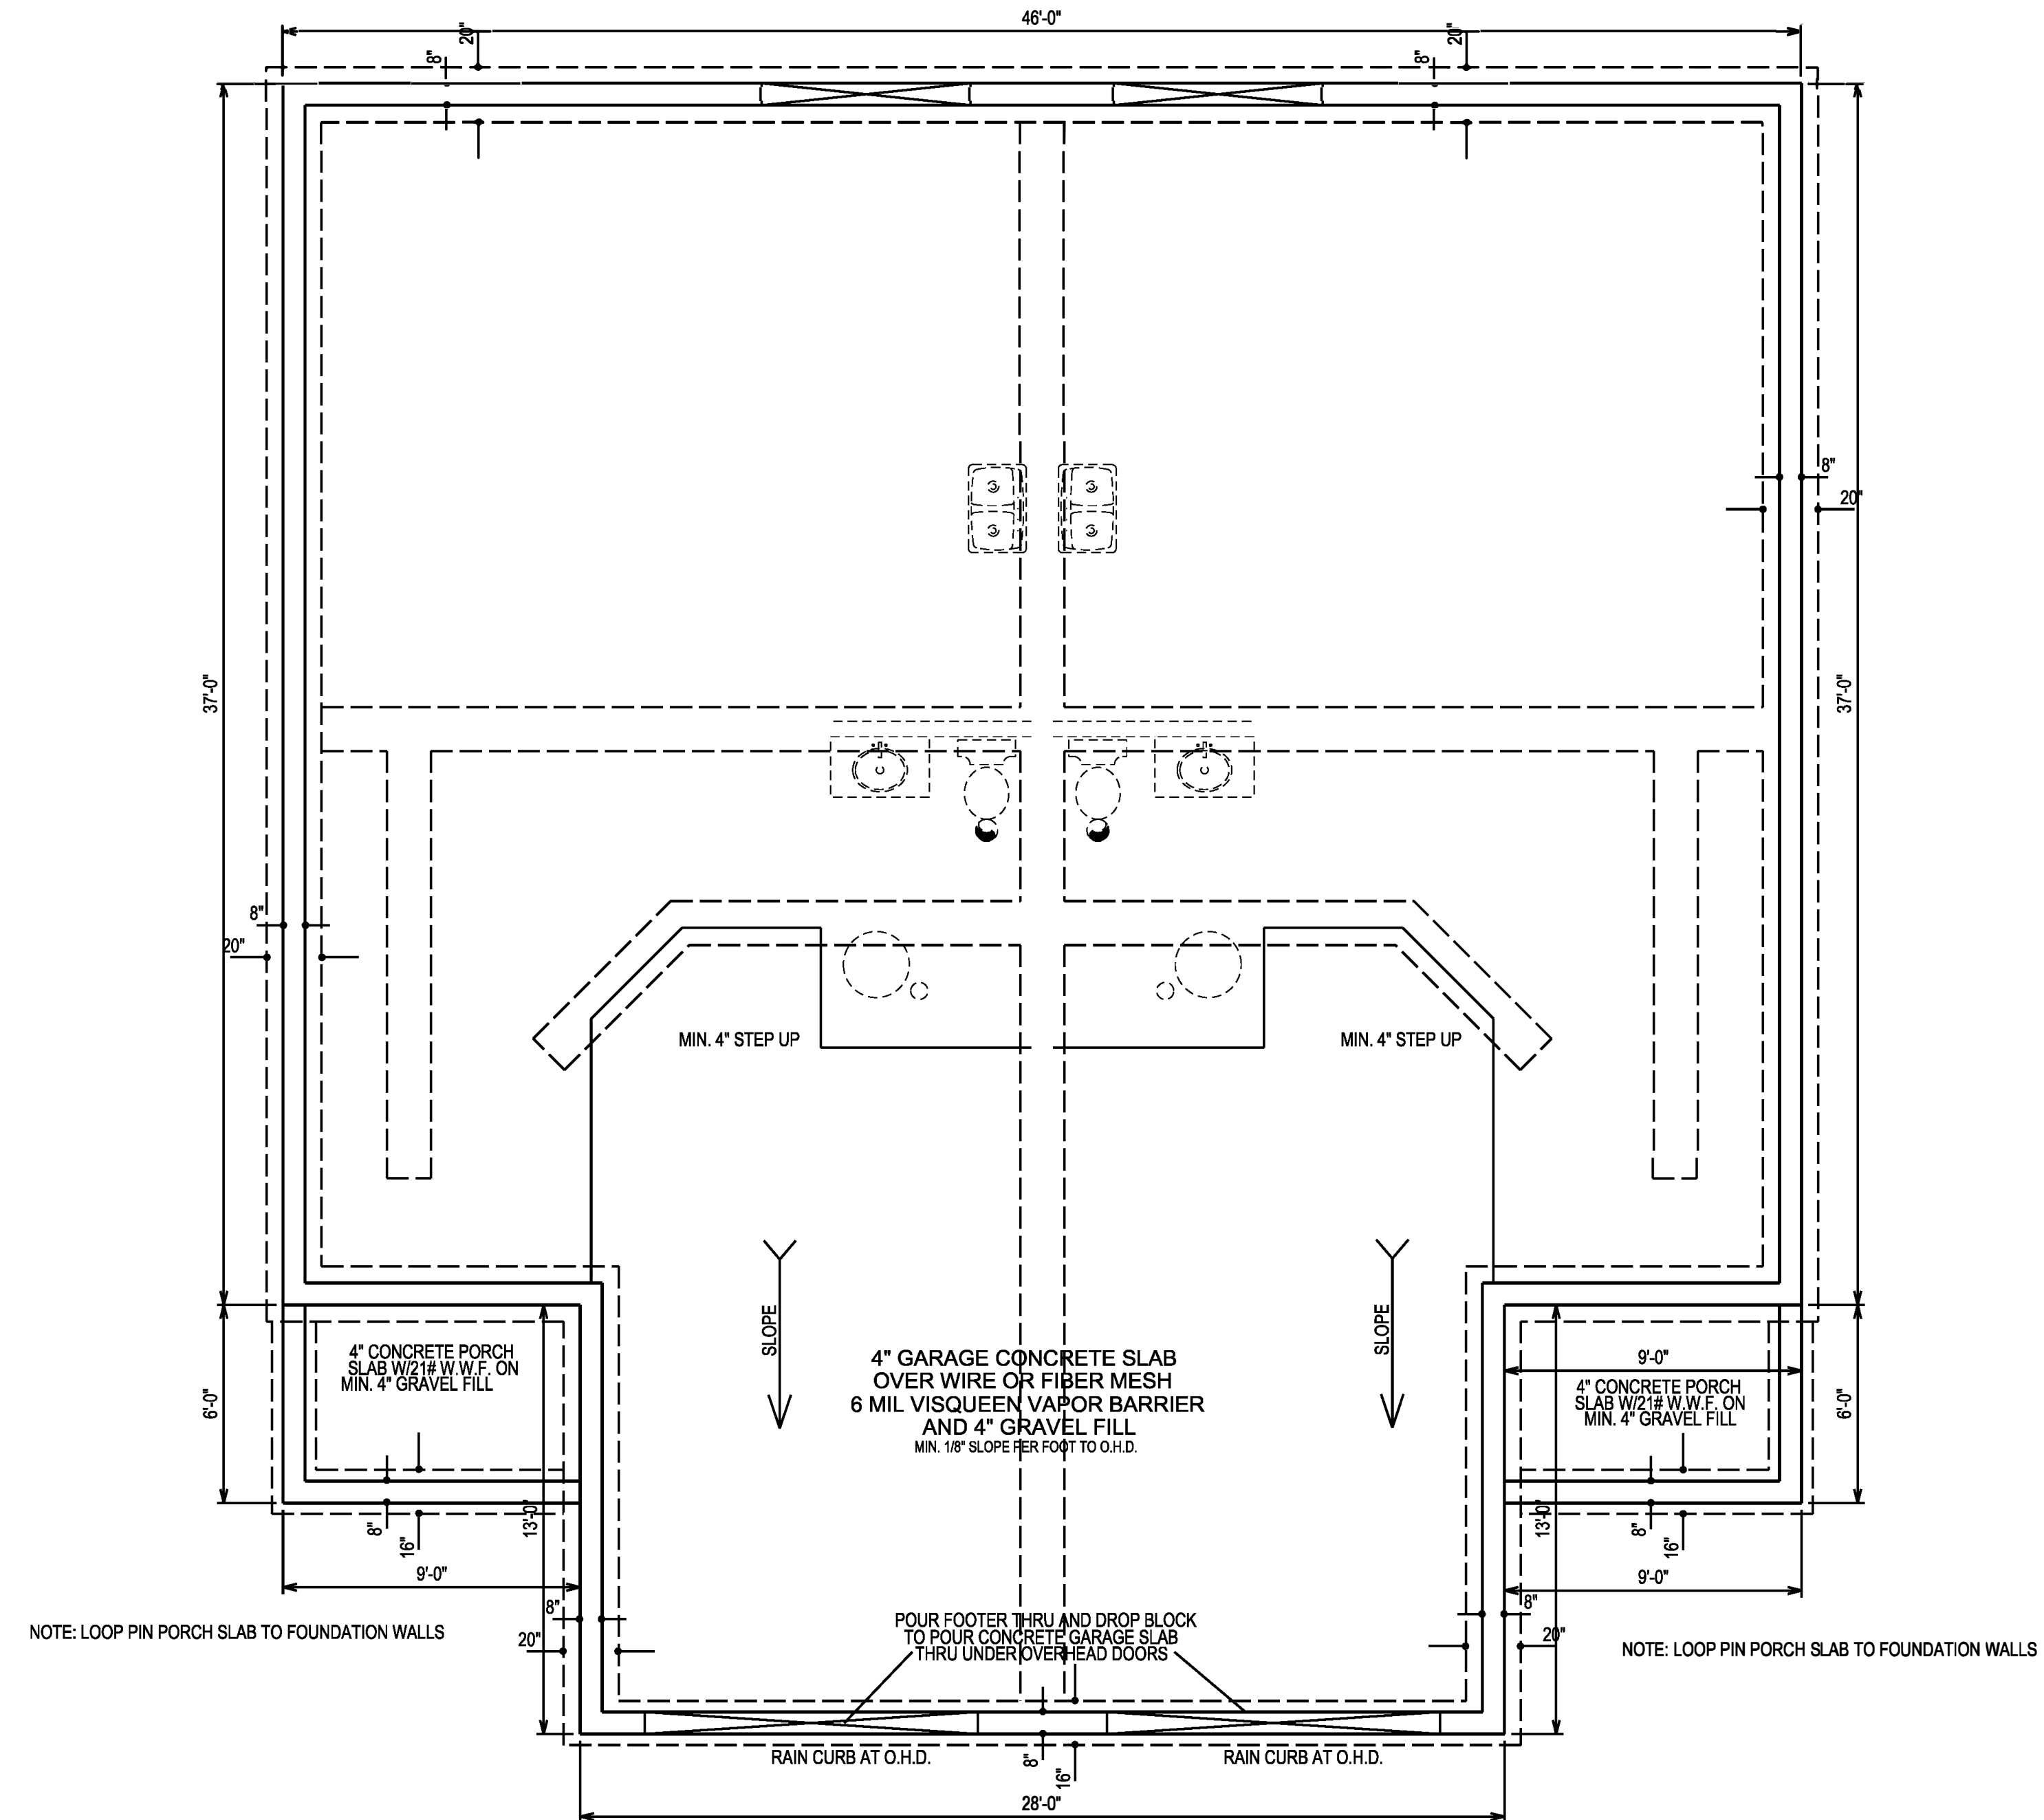

UNIT B
- FOOTER AND FOUNDATION PLAN -

DRAWING #

PRELIMINARY PLANS FOR
2 BEDROOM/ 2 1/2 BATH (B)
FULLENKAMP DUPLEXES
NEWPORT VILLAGE


DATE:
PHASE 1
2-5-2024
2-16-2024
PHASE 2
3-8-2024

SCALE:
1/4" = 1'-0"


DRAWN BY:
C. ALAN
HARSHMAN



- REAR ELEVATION -

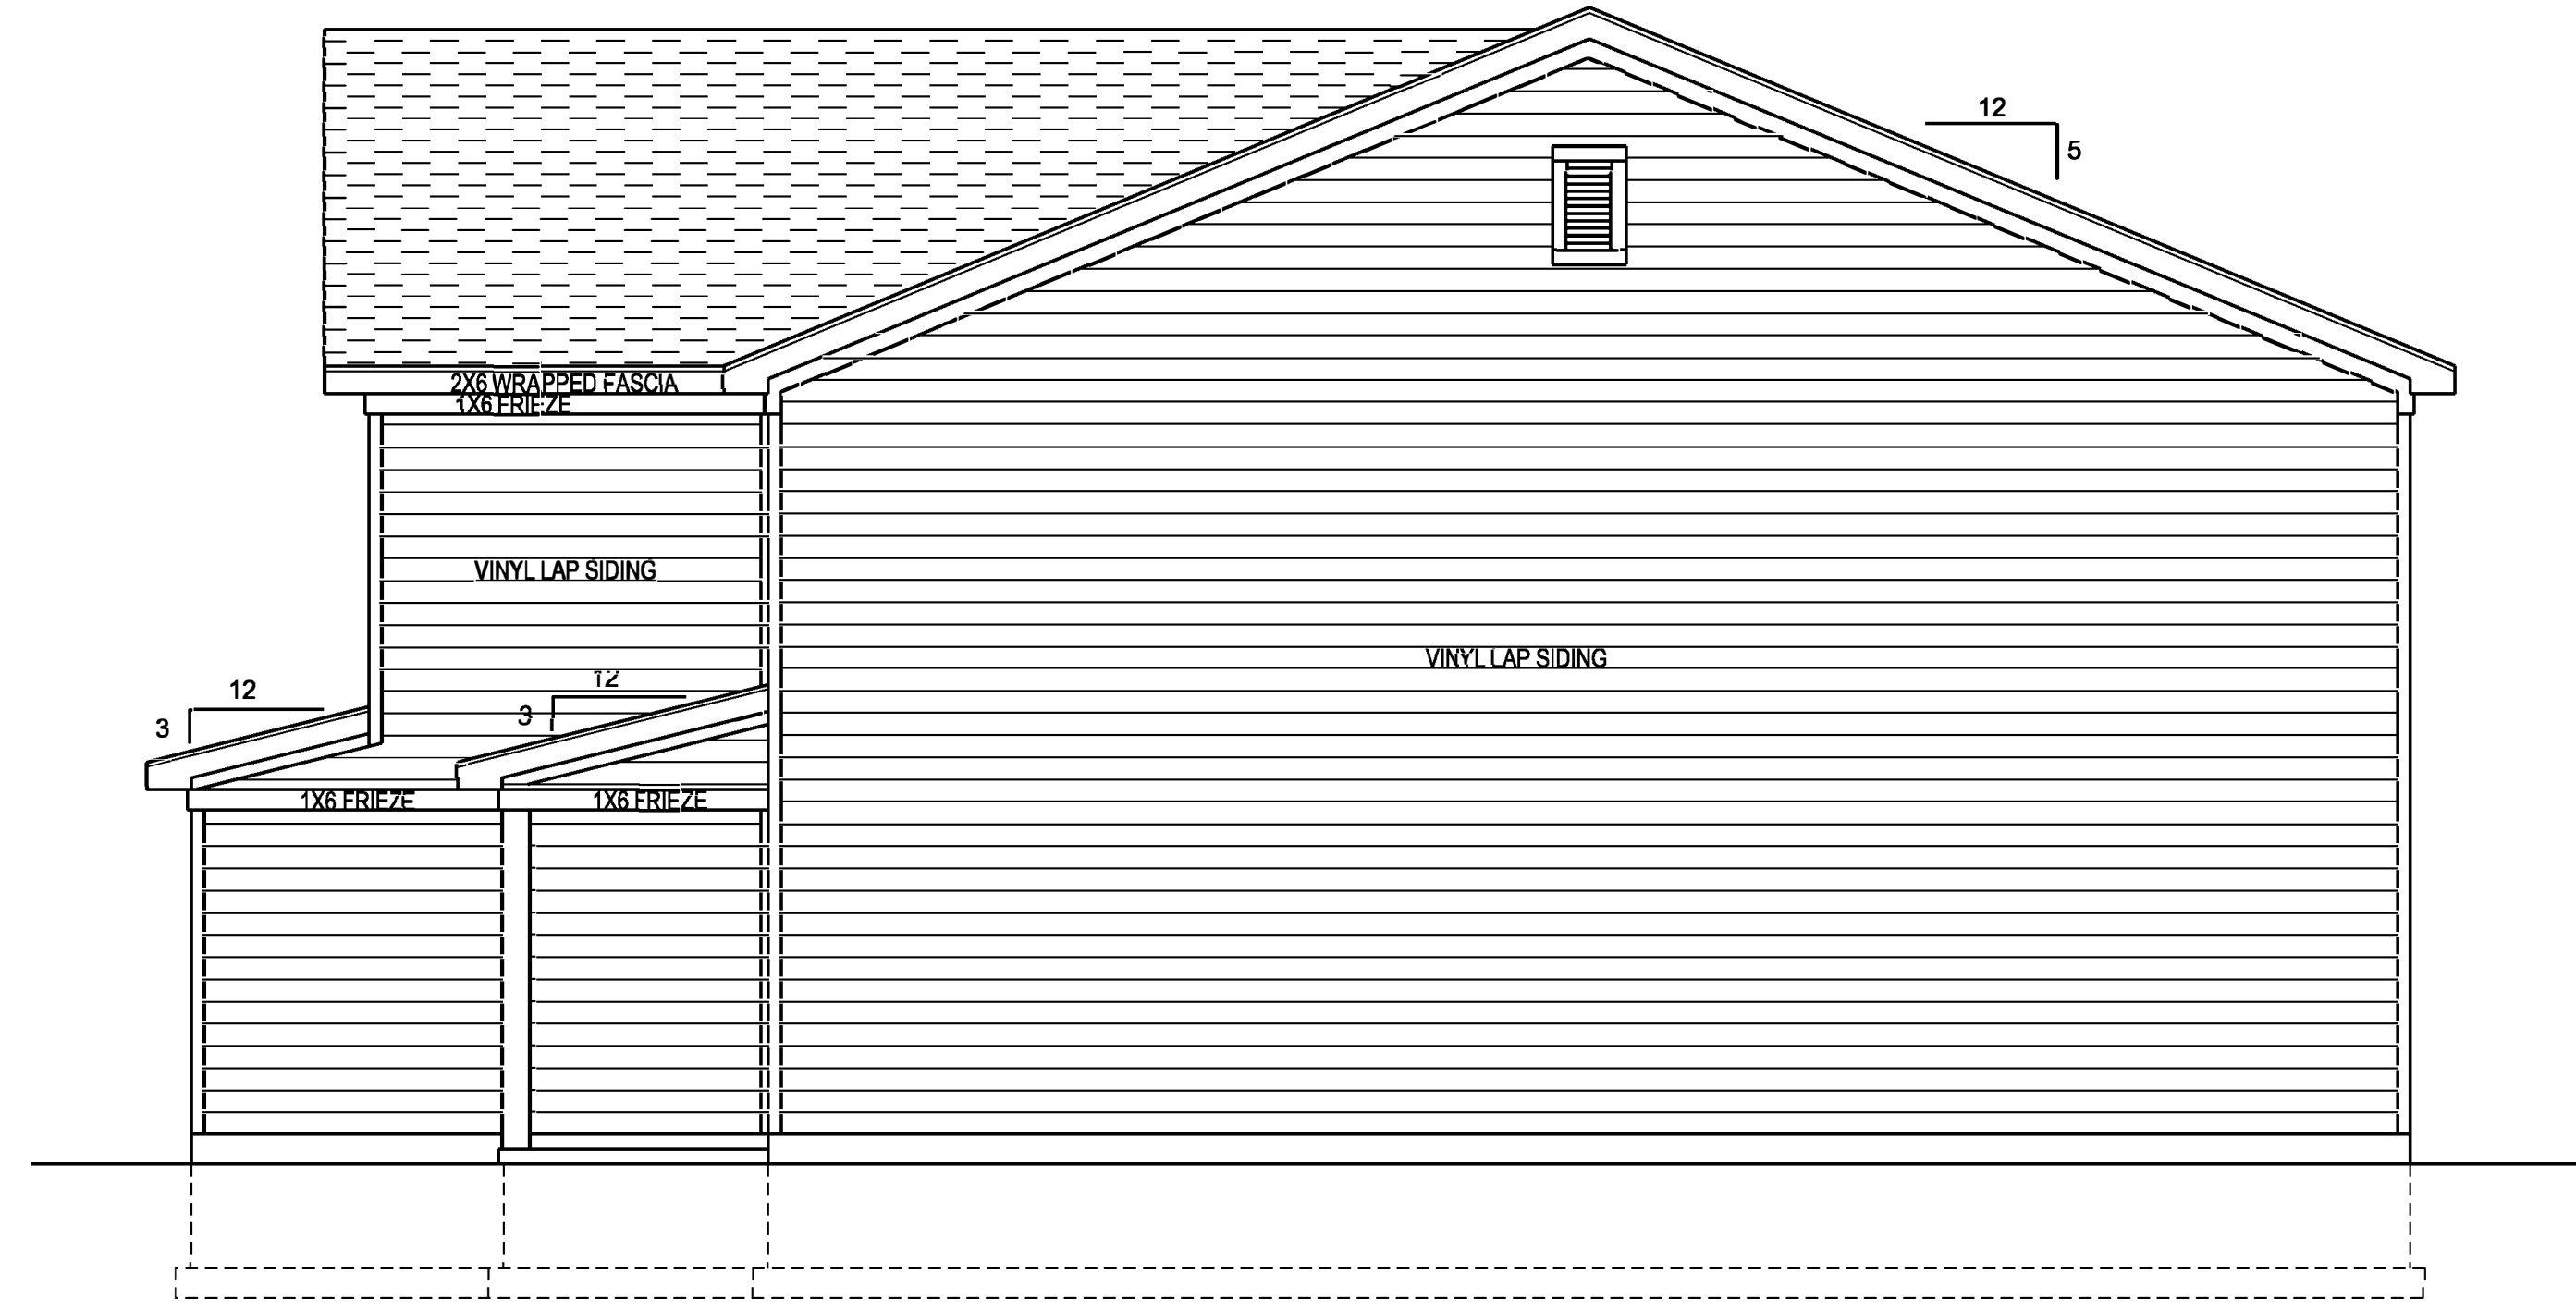

- RIGHT ELEVATION -

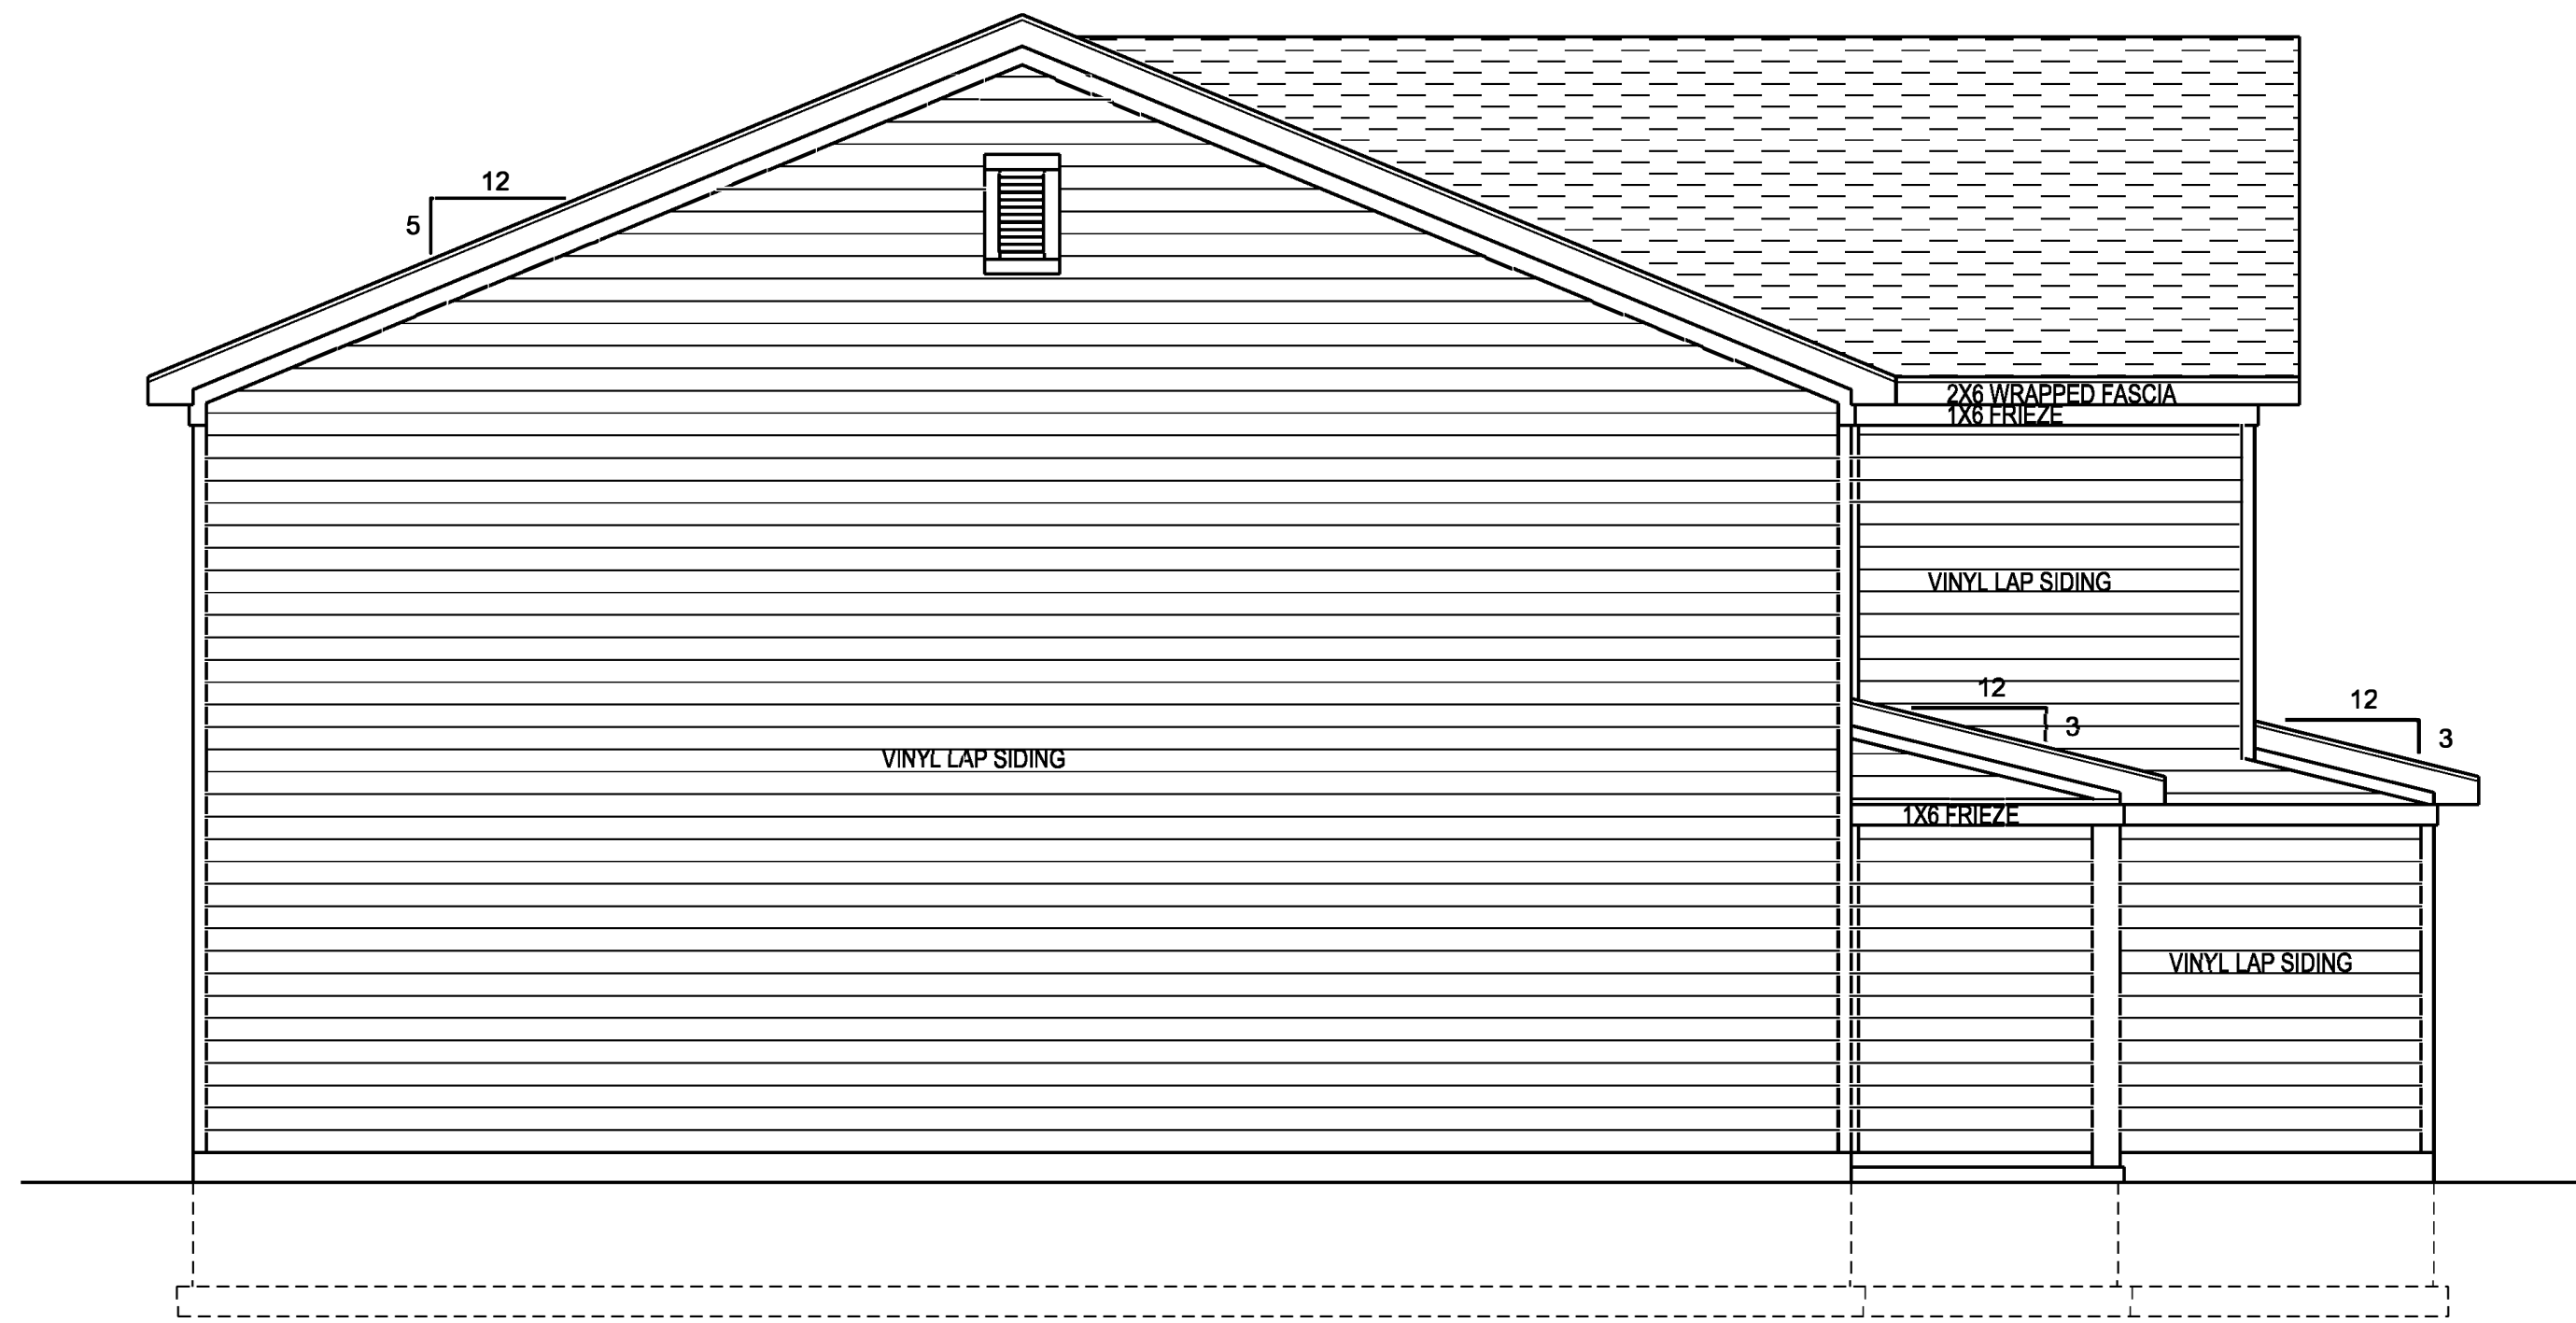

- LEFT ELEVATION -



- FRONT ELEVATION -


DRAWING #

PRELIMINARY PLANS FOR
 2 BEDROOM/ 2 1/2 BATH
 FULLENKAMP DUPLEXES
 NEWPORT VILLAGE

DATE:
 PHASE 1
 2-5-2024
 2-16-2024
 PHASE 2
 2-27-2024


SCALE:
 1/4" = 1'-0"

DRAWN BY:
 C. ALAN
 HARSHMAN

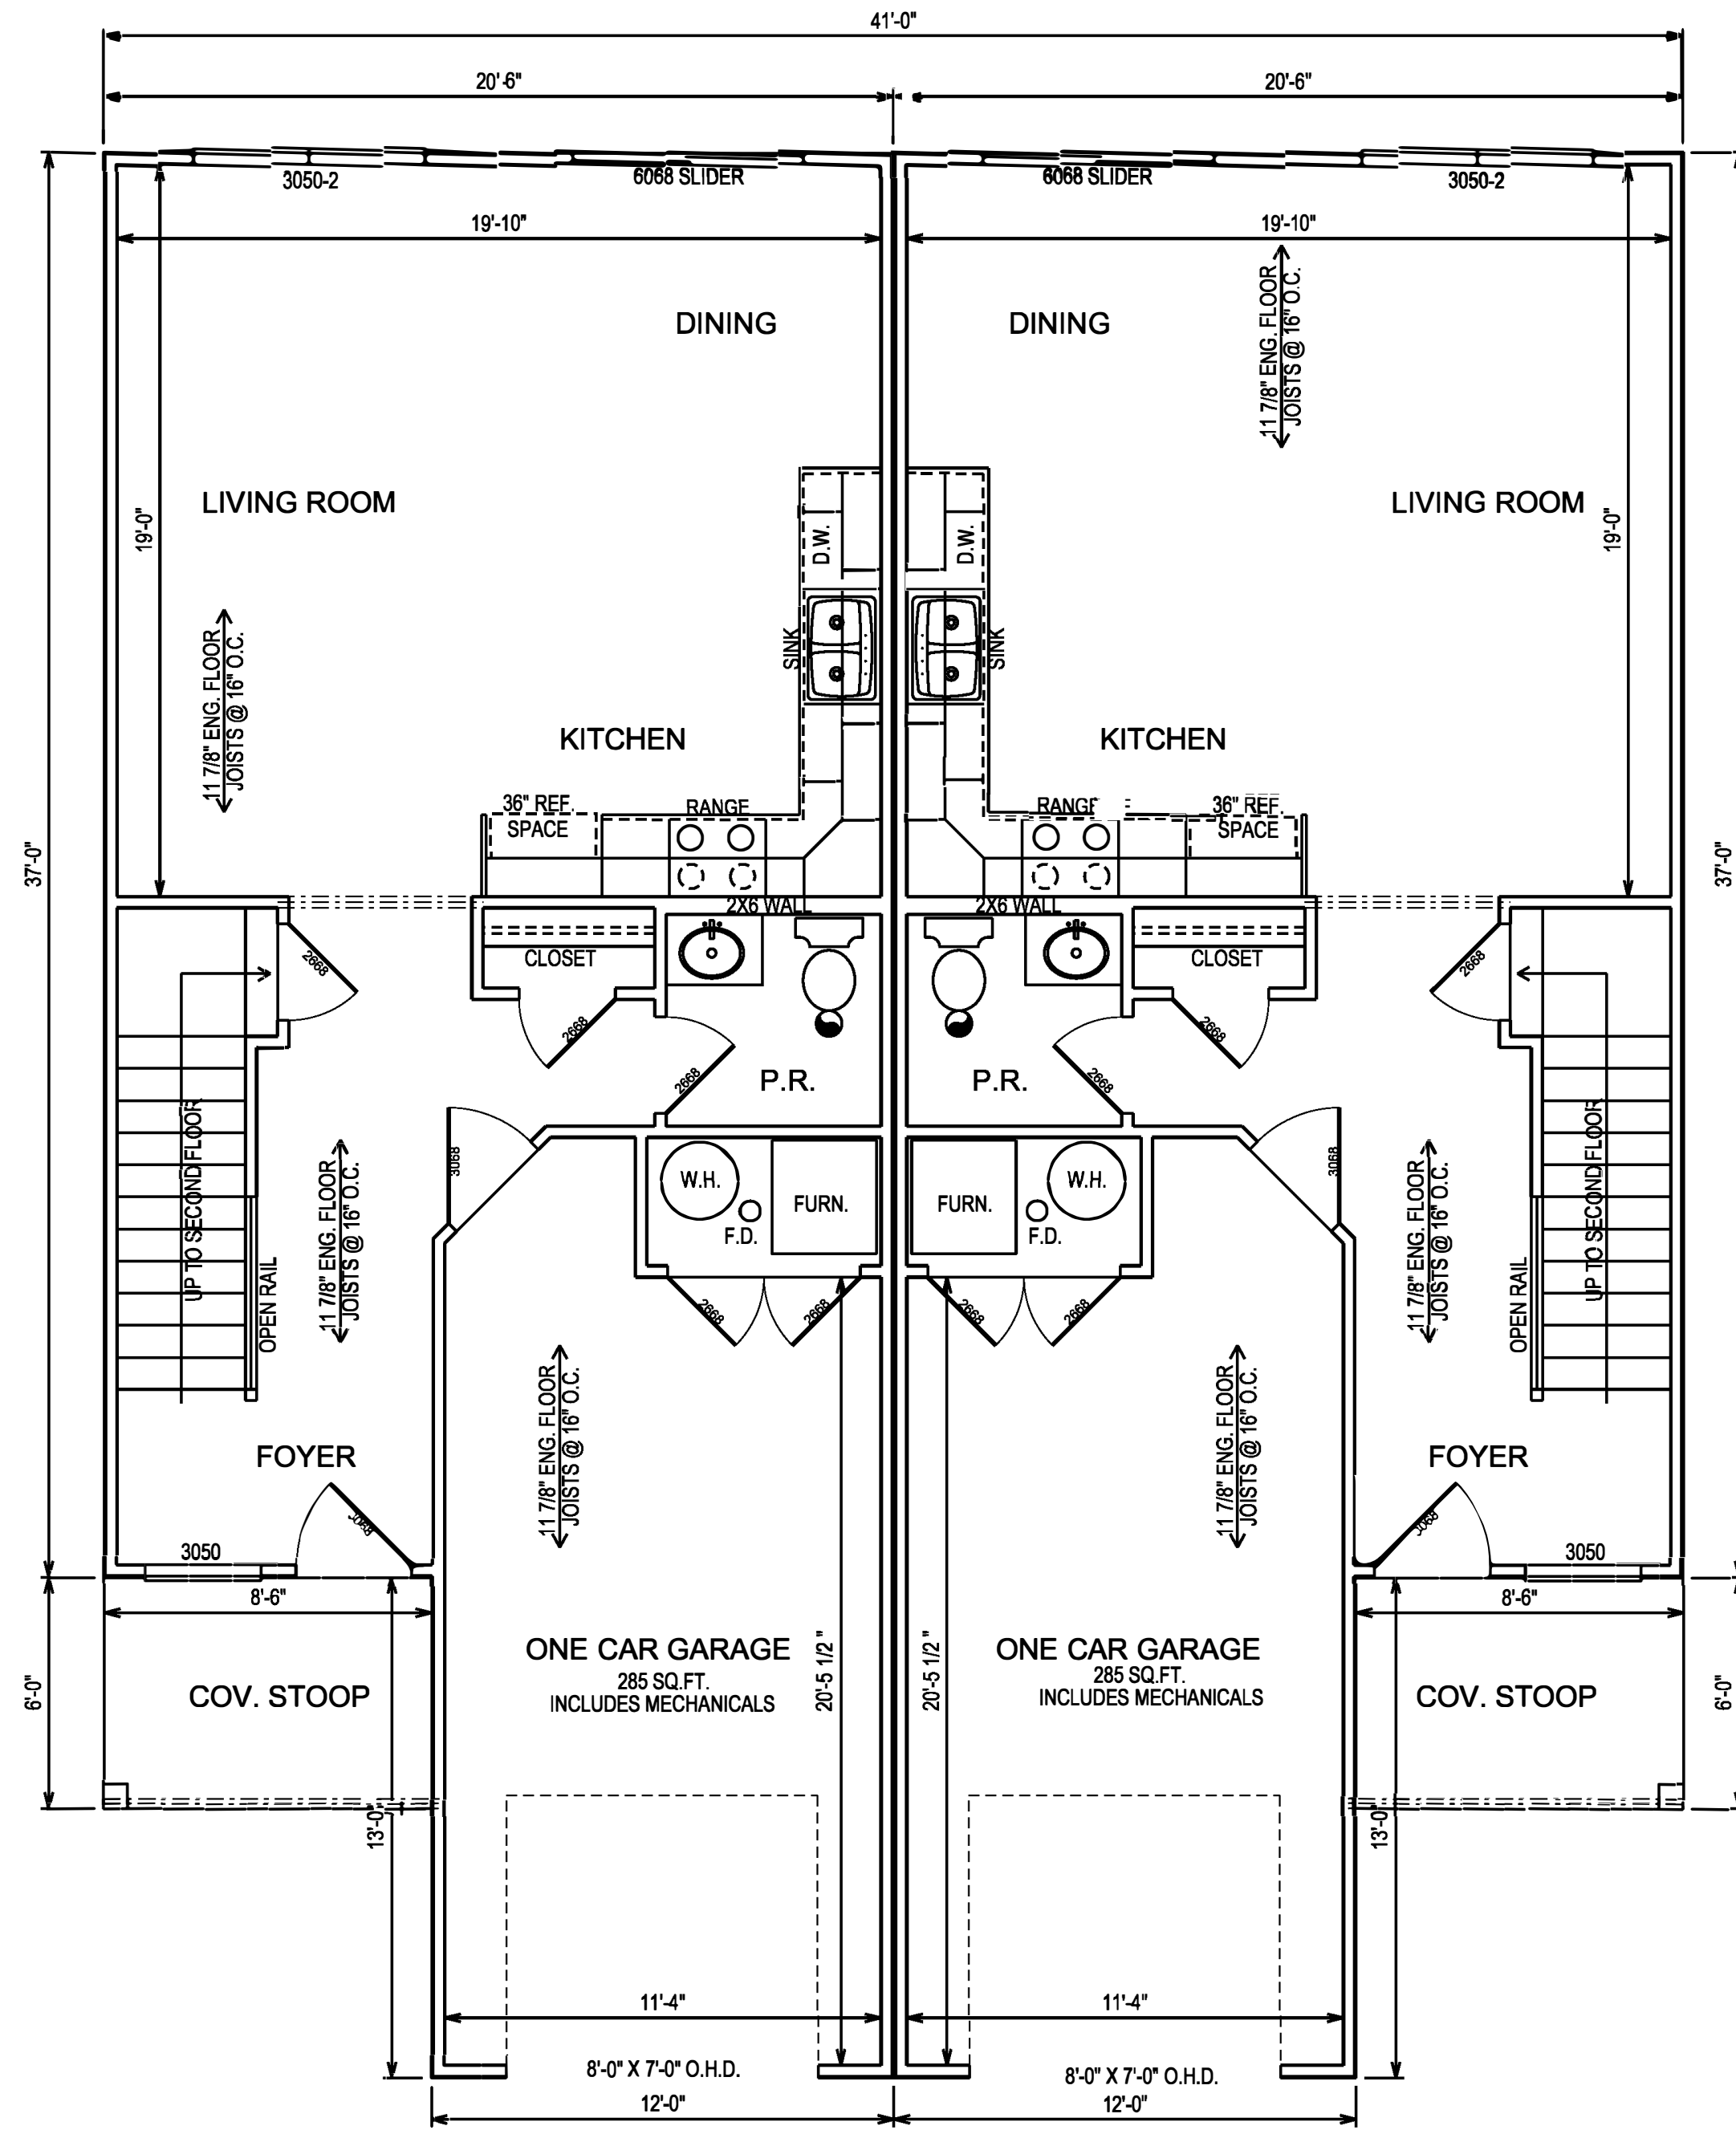

- FIRST FLOOR PLAN -
630 SQ.FT.
8'-0" CEILING HEIGHT

- FIRST FLOOR PLAN -
630 SQ.FT.
8'-0" CEILING HEIGHT

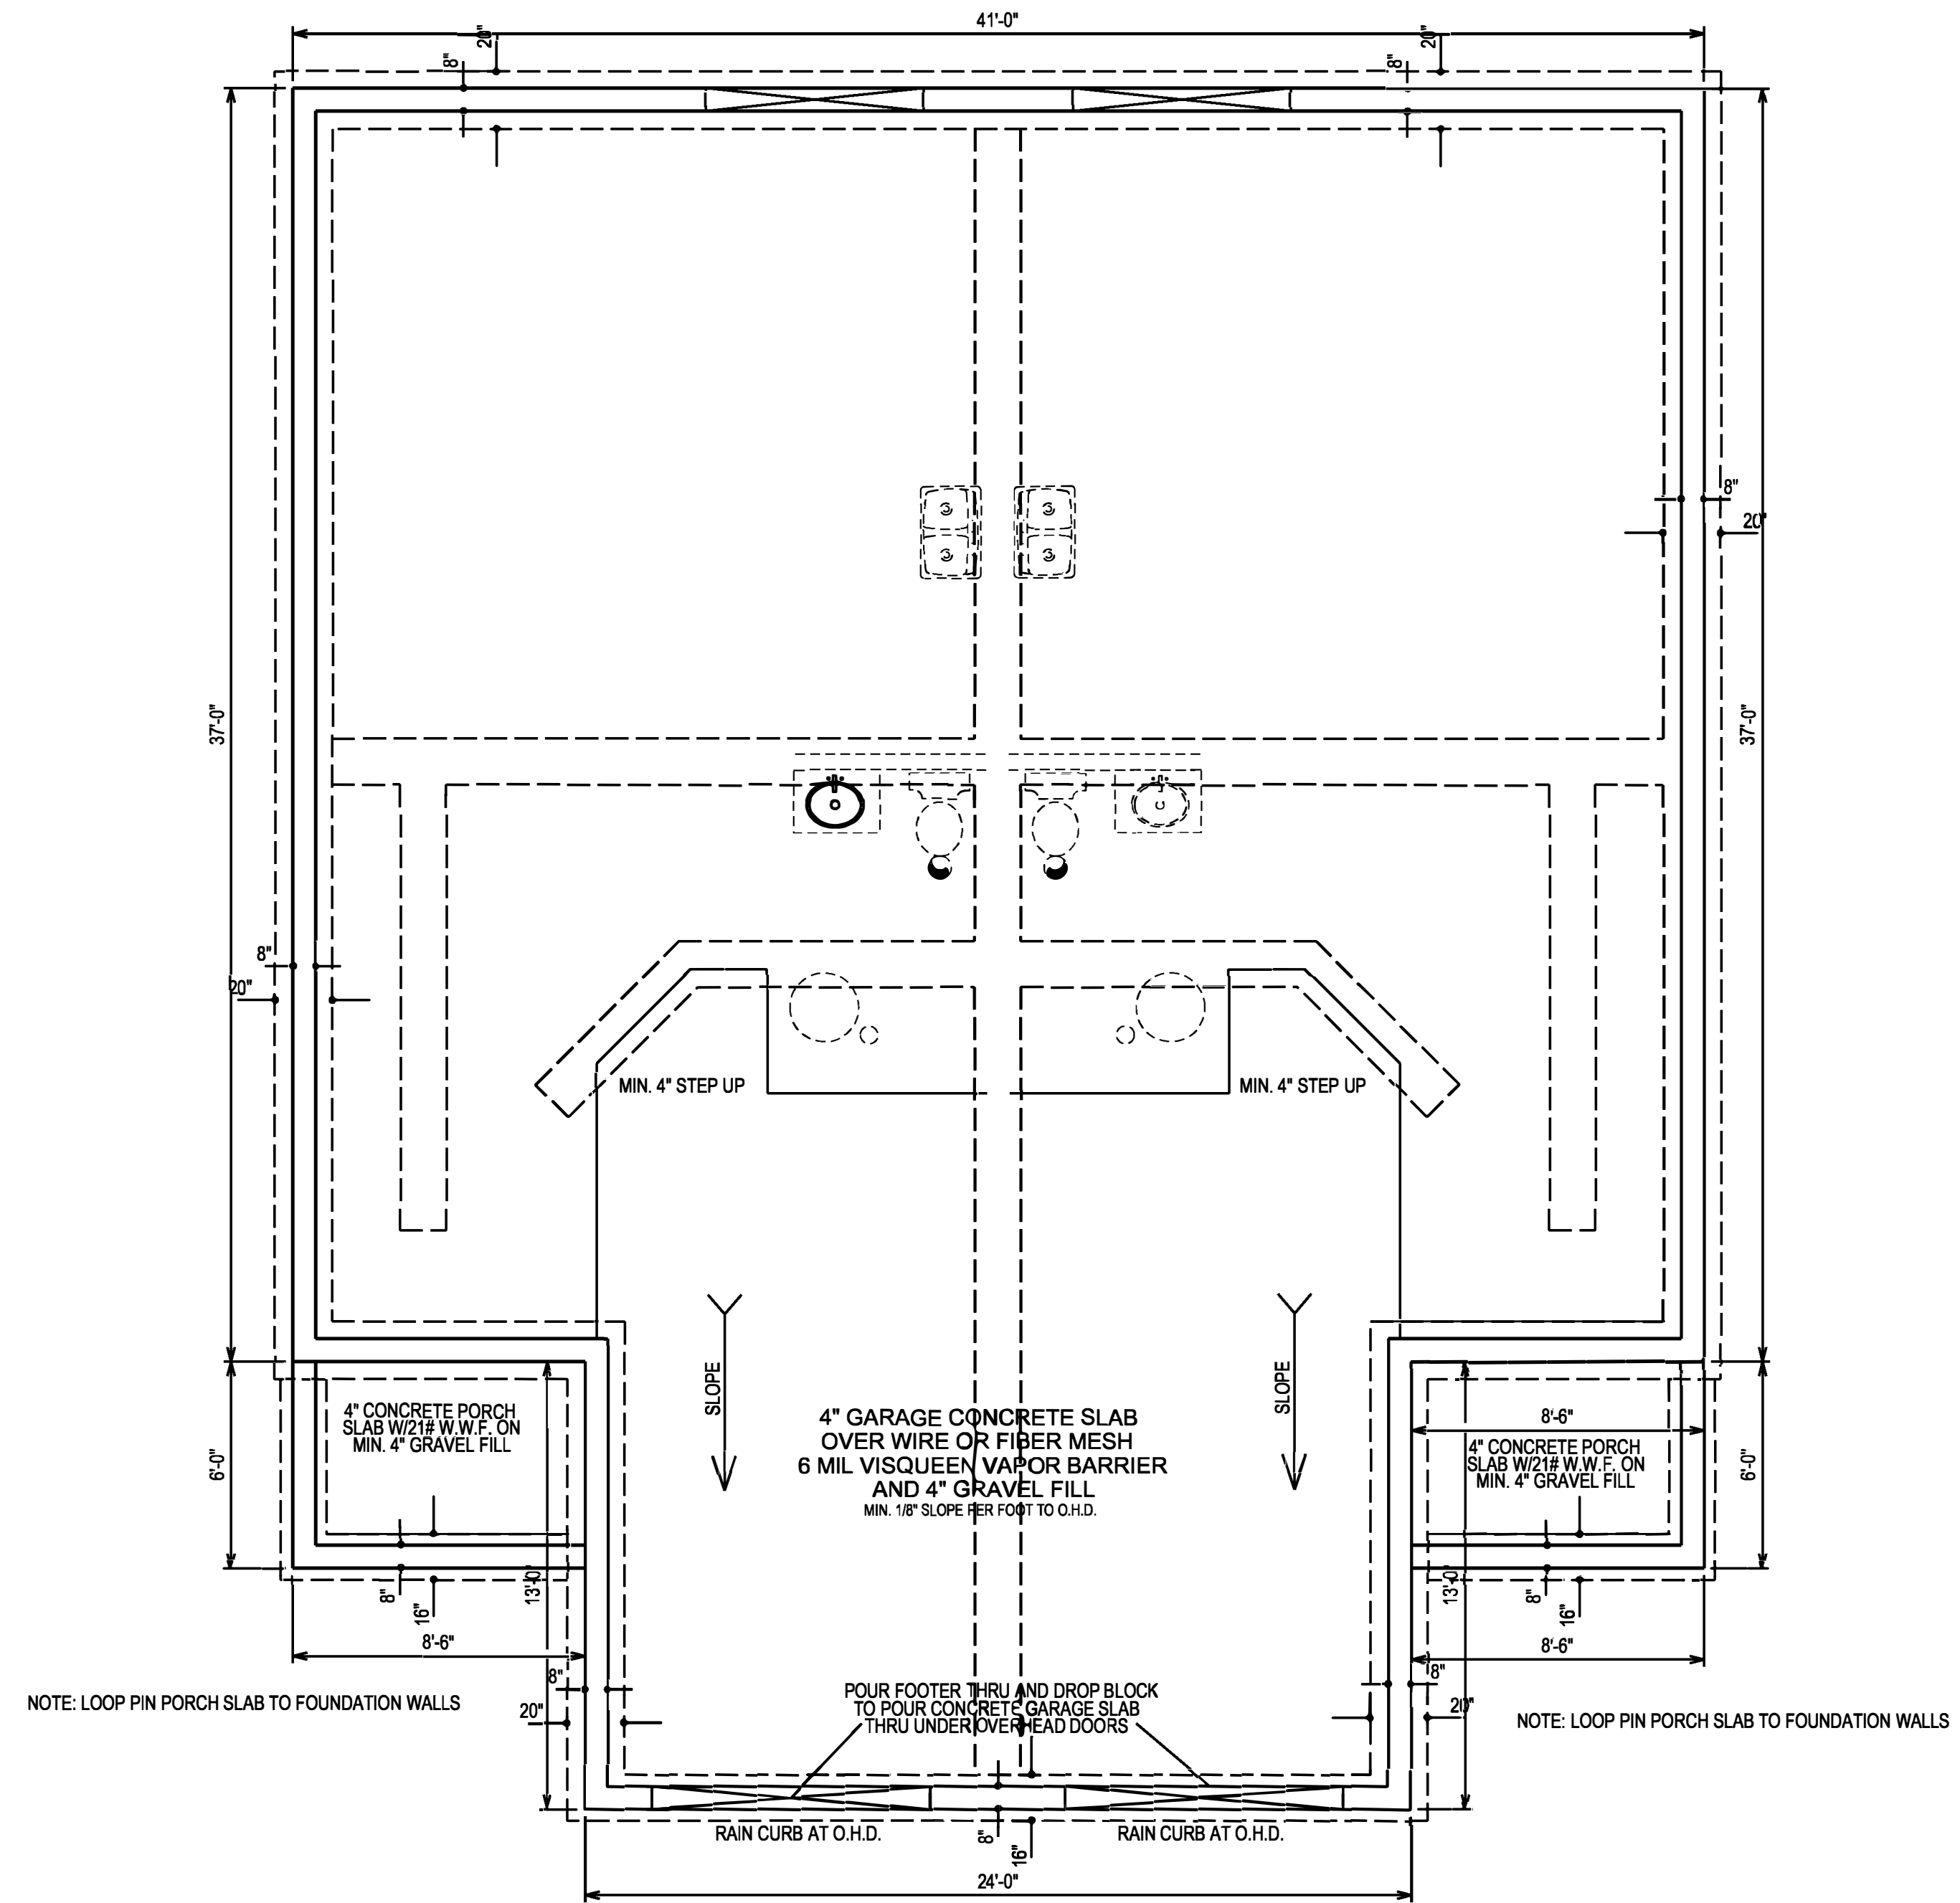

- FOOTER AND FOUNDATION PLAN -

DRAWING #

PRELIMINARY PLANS FOR
2 BEDROOM/2 1/2 BATH
FULLENKAMP DUPLEXES
NEWPORT VILLAGE

DATE:
PHASE 1
2-5-2024
2-16-2024
PHASE 2
2-27-2024

SCALE:
1/4" = 1'-0"

DRAWN BY:
C. ALAN
HARSHMAN